

Memorandum Development Services - Memo No. PZ20-036

Date: October 21, 2020

To: Planning and Zoning Commission

Thru: Kevin Mayo, Planning Administrator

David De La Torre, Planning Manager

From: Susan Fiala, AICP, Senior Planner 🗲

Subject: PLH20-0013 ALTA CHANDLER AT THE PARK

Reguest: Rezone from Planned Area Development (PAD) to PAD for

multi-family with a Mid-Rise Overlay and Preliminary Development Plan approval for a 293 unit apartment

development

Location: Southwest corner of Chandler and Parklane Blvd.

Applicant: Brennan Ray, Burch & Cracchiolo, P.A.

Background

• Site is approximately 6.49 net acres

- Site was zoned in 1982 as part of the larger 60 acre "The Park" master plan; portions were built, then zoning lapsed on undeveloped parcels resulting in a 1996 PAD amendment
- Site contains three parcels of which one is developed with medical office and general office. South parcel is vacant, formerly proposed for office.

Surrounding Land Use Data

North	Commercial and single-family	South	Multi-family residential
	residential		
East	Shopping Center (The Park –	West	Office, medical office
	anchored by Safeway, Home Depot)		

Memo No. PZ20-036 Page 2 of 6 October 21, 2020

General Plan

	Existing	Proposed
General Plan	Neighborhoods -	N.A.
	(High Capacity Transit	
	Corridor)	

Proposed Development

Proposed Developm	<u>ent</u>	
Density and Units	45 dwelling units per acre	 293 units total 183 - 1 bedroom units 99 - 2 bedroom units 11 - 3 bedroom units
Building Height	Mid-Rise Overlay	 Maximum height of 63 ft. inclusive of architectural elements, parapets, screening, stair wells, elevator shafts 43 ft. typical to roof deck
Site Development	 3 buildings 4 stories Carports	Ride share zoneDog Park
Building Architecture	Contemporary	 Stacked stone and brick veneers Stucco and fiber cement siding Metal railings and accents Metal canopy projections with brackets Stucco clad cornices
Parking Spaces	 498 spaces required 461 spaces proposed (See discussion below) 	 108 Private garages 108 Tandem 186 Covered 7 Uncovered 52 Guest (on-site) 22 On-street
Amenities	 Outdoor pool Spa Cabanas Dog spa Bike Shop Clubhouse 	

Memo No. PZ20-036 Page 3 of 6 October 21, 2020

Review and Recommendation

Planning staff finds the proposal is consistent with the General Plan designation of Neighborhoods. Urban densities exceeding 18 dwelling units per acre can be considered within designated high-capacity transit corridors such as Chandler Blvd. The site is considered as a redevelopment of an underutilized office site as well as infill. The site is proximate to Downtown Chandler and located along a corridor with Valley Metro bus service and bike lanes.

The site layout provides a gated main entrance off of Parklane Blvd., a private street, and a secondary drive on Commonwealth St. Pedestrians are provided with a shaded, tree-lined sidewalk along Chandler Blvd and pedestrian pathways leading to The Park shopping center, located to the east.

Building architecture is of a contemporary style with use of rectilinear forms creating recessed alcoves, extruded balconies and patios, and metal bracketed canopies. Building materials are placed to create a gentle movement of the façade with a modern light paint palette. A two story, glass entry at the northeast portion of Building One, opens the visibility of the development to Chandler Blvd. Also located in this portion of the site is the project monument sign designed with contemporary modern materials and similar forms to complement the "The Park" sign located directly to the east.

Staff finds the proposal to be consistent with the goals of the General Plan, and recommends approval.

Traffic and Parking Analyses

A Traffic Impact Analysis was prepared to compare the existing office development with the proposed multi-family development. Trip generation increased for total weekday trips with a reverse AM and PM peak hours and Total Peak hour trips for the multi-family development. However, when looking at the number of AM in/out, the proposed multi-family has less inbound AM Peak hour trips and more outbound peak trips than the existing office in the AM. A similar reversal at the PM Peak Hour was found. The intersection of Chandler and Parklane is signalized and may need the traffic signal timing adjusted with potential future changes in traffic patterns. The City Traffic Engineer found no concerns with the Analysis.

A Parking Demand Study was prepared to determine if the request to reduce required parking by 7.4 percent is sufficient for the development. A 37 parking space reduction is proposed from the required 498 parking spaces to 461 on-site parking spaces. Unassigned on-site parking provides 52 guest parking spaces and 22 spaces on Parklane Blvd. and Commonwealth St. for a total of 74 guest spaces at a ratio of one space for every four units.

Memo No. PZ20-036 Page 4 of 6 October 21, 2020

A comparison of parking reduction rates between this proposal and two similar existing multi-family developments, Olympus Steelyard and The Met at Chandler Fashion Center, was evaluated. Olympus Steelyard has a 7.5% reduction and The Met has a 6% reduction from parking requirements. The study concluded that the request for Alta Chandler at The Park aligns with the parking reduction ratios of these recently constructed multi-family developments.

Public / Neighborhood Notification

- This request was noticed in accordance with the requirements of the Chandler Zoning Code.
- Two virtual neighborhood meetings were held on August 20⁻ 2020 and August 25, 2020. No one other than the applicant's team and City staff registered and attended either of the virtual meetings. Two residents called requesting general project information prior to the virtual meeting. No concerns or opposition voiced.
- As of writing this memo, Planning staff received one phone call from a resident stating their opposition to the request.

Recommended Actions

Rezoning

Planning staff recommends Planning and Zoning Commission move to recommend approval of rezoning from PAD to PAD multi-family with a Mid-Rise Overlay for buildings up to 63 feet, subject to the following conditions:

- 1. Development shall be in substantial conformance with the Development Booklet, entitled "Alta Chandler at The Park" and kept on file in the City of Chandler Planning Division, in File No. PLH20-0013, modified by such conditions included at the time the Booklet was approved by the Chandler City Council and/or as thereafter amended, modified or supplemented by the Chandler City Council.
- 2. High density residential shall be permitted with a maximum density of forty five (45) dwelling units per acre.
- 3. Building heights shall be limited to a maximum of 63 feet in height.
- 4. Completion of the construction of all required off-site street improvements including but not limited to paving, landscaping, curb, gutter and sidewalks, median improvements and street lighting to achieve conformance with City codes, standard details, and design manuals.
- 5. Minimum setbacks shall be as provided below and further detailed in the Development Booklet:

Memo No. PZ20-036 Page 5 of 6 October 21, 2020

Building setbacks (min.)

North (Chandler Blvd.) 10 ft. (29 ft. to curb) East (Parklane Blvd.) 10 ft. (16 ft. to curb)

South (Commonwealth St.) 10 ft. West 10 ft.

Preliminary Development Plan

Planning staff recommends Planning and Zoning Commission move to recommend approval of the Preliminary Development Plan, subject to the following conditions:

- 1. Development shall be in substantial conformance with the Development Booklet, entitled "Alta Chandler at The Park" and kept on file in the City of Chandler Planning Division, in File No. PLH20-0013, modified by such conditions included at the time the Booklet was approved by the Chandler City Council and/or as thereafter amended, modified or supplemented by the Chandler City Council.
- 2. The site shall be maintained in a clean and orderly manner.
- 3. The landscaping in all open-spaces shall be maintained by the property owner or property owners' association, and shall be maintained at a level consistent with or better than at the time of planting.
- 4. The landscaping in all rights-of-way shall be maintained by the adjacent property owner or property owners' association.
- 5. Landscaping plans (including for open spaces, rights-of-way, and street medians) and perimeter walls shall be approved by the Planning Administrator.
- 6. Sign packages, including free-standing signs as well as wall-mounted signs, shall be designed in coordination with landscape plans, planting materials, storm water retention requirements, and utility pedestals, so as not to create problems with sign visibility or prompt the removal of required landscape materials.
- 7. Preliminary Development Plan approval does not constitute Final Development Plan approval; compliance with the details required by all applicable codes and conditions of the City of Chandler and this Preliminary Development Plan shall apply.
- 8. The developer shall install stamped concrete pedestrian crosswalks at the Parklane Blvd. and Commonwealth St. intersection, as represented in the Development Booklet.

Memo No. PZ20-036 Page 6 of 6 October 21, 2020

Proposed Motions

Rezoning


Move Planning and Zoning Commission recommend approval of <u>PLH20-0013 ALTA CHANDLER AT THE PARK</u> rezoning from PAD to PAD multi-family with a Mid-Rise Overlay for buildings up to 63 feet, subject to the conditions as recommended by Planning staff.


Preliminary Development Plan

Move Planning and Zoning Commission recommend approval of Preliminary Development Plan, <u>PLH20-0013 ALTA CHANDLER AT THE PARK</u>, subject to the conditions as recommended by Planning staff.

Attachments:

- 1. Vicinity Maps
- 2. Development Booklet, Attachment A

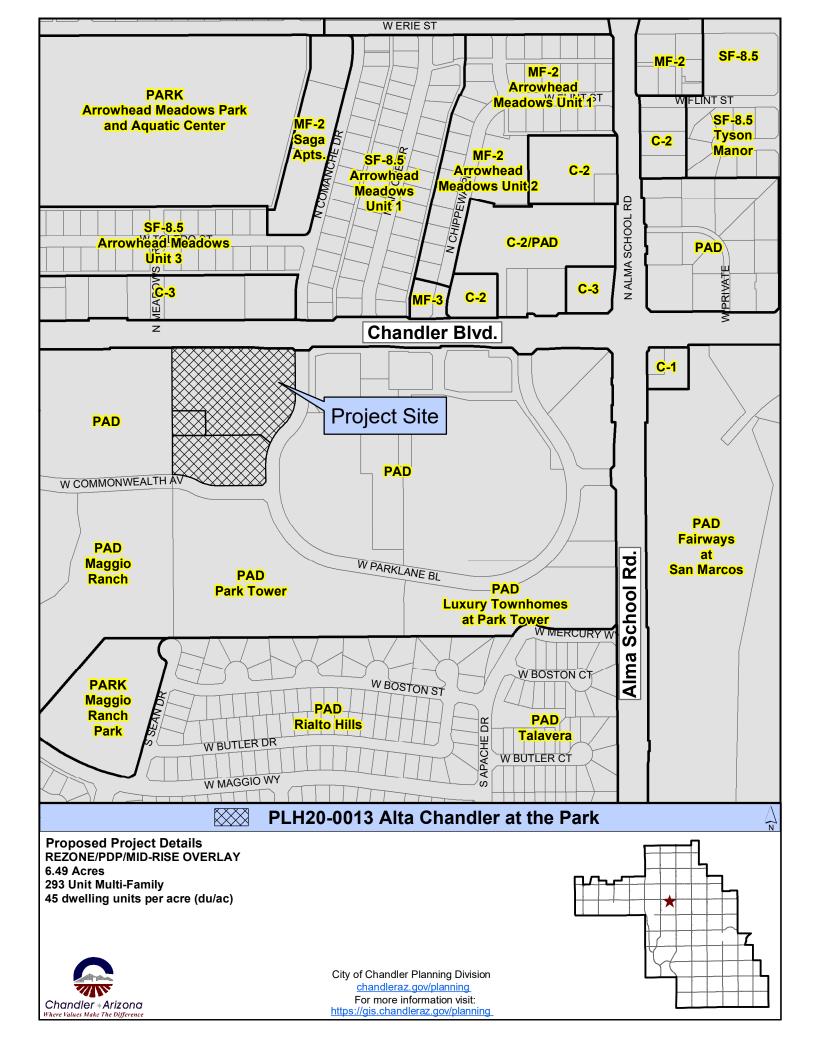

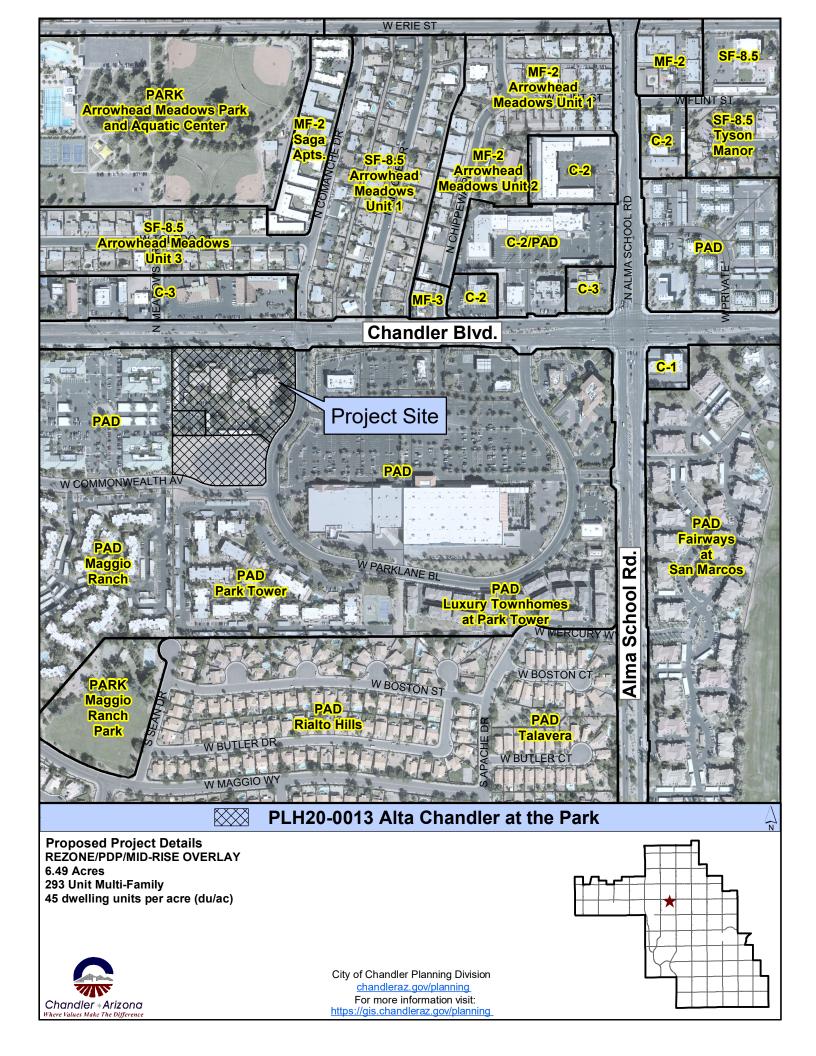

Alta Chandler at the Park

Planned Area Development, Preliminary Development Plan, and Mid-Rise Overlay

SWC Chandler Boulevard and Parklane Boulevard

CASE NO. PLH20-0013



Submitted: February 2020 Revised: July 1, 2020 Revised: September 15, 2020 Revised: October 2, 2020

DEVELOPMENT TEAM

DEVELOPER:

Wood Partners

Contact: Clay Richardson Managing Director 8777 E. Via De Ventura, Suite 201 Scottsdale, AZ 85258

O: 480.567.0520



ARCHITECT:

Biltform Architecture Group of Companies

Contact: Jim Applegate

Principal

11460 N Cave Creek Rd #11

Phoenix, AZ 85020 Phone: (602) 285-9200 Fax: (602) 285-9229

BILTFORM

LANDSCAPE ARCHITECT:

ABLA

Contact: Andy Baron

President

310 E. Rio Salado Parkway

Tempe, AZ 85281 Phone: (480) 530-0077



ATTORNEYS:

Earl & Curley

Contact: Stephen Earl

Development Manager: Gary King 3101 N. Central Avenue, Suite 1000

Phoenix, Arizona 85012 Phone: (602) 265-0094 Fax: (602) 265-2195



Burch & Cracchiolo, P.A.

Contact: Ed Bull/Brennan Ray 1850 N. Central Avenue, 17th Floor

Phoenix, Arizona 85004 Phone: (602) 234-8794



TABLE OF CONTENTS

I.	INTRODUCTION	
II.	DEVELOPER BACKGROUND	3
III.	SITE, SURROUNDING AREA and EXISTING ZONING	4
IV.	PROPOSED PAD AMENDMENT, PDP and MR OVERLAY	5
A.	. Planned Area Development (PAD) and Mid-Rise (MR) Overlay	5
	Preliminary Development Plan (PDP) 1. Landscaping	
C.	Development Standards	9
D.	. Miscellaneous	10
V.	MULTI-FAMILY DESIGN STANDARDS	10
VI.	CONCLUSION	

TABLE OF EXHIBITS

Exhibit No.	Description	
1	Aerial Context Map	
2	Perspectives	
3	Preliminary Site Plan	
4	Conceptual Landscape Plan	
5	Amenity Plan	
6	Building Elevations	
7	Floor and Roof Plans	
8	Color & Materials Palette	
9	Circulation Plan	
10	Wall Plan & Elevations	
11	Monument Sign & Site Details	
12	Preliminary Grading & Drainage Plan	

NARRATIVE

I. <u>INTRODUCTION</u>

Continuing on its reputation of building high-quality multi-family developments, Wood Partners is the proposed developer of approximately 8.14 gross (6.5± net) acres located at the southwest corner of Chandler Boulevard and Parklane Boulevard (the "Site"). Wood Partners anticipated developing this redevelopment/infill Site with a luxury multi-family community known as "Alta Chandler at the Park." Alta Chandler at the Park will consist of 4-story buildings with 293 units, a density of 45.08 dus/net ac. To achieve this, Wood Partners requests to amend the existing Planned Area Development ("PAD") zoning and obtain Preliminary Development Plan ("PDP") and Mid-Rise overlay approval.

Grossman Company Properties owns the Site as well as the adjacent shopping center at the southeast corner of Chandler Boulevard and Parklane Boulevard that includes the Bank of America, Home Depot, Safeway, and many other tenants. Grossman Company has owned and developed many properties in the metro Phoenix area over the past forty years and has owned this Site and the shopping center since the 1990's.

The office development currently on the Site was part of the first phase of a larger 60-acre PAD master plan that was originally approved for this area that at the time of approval included a major retail mall. Despite being constructed and operating, this office development did not lead to the larger retail mall developing nor the office on the vacant 1.92 acres to the south. The large retail mall component of the master plan was converted into a power center in the mid 1990's.

All of the marketing efforts for additional office development on the Site have proven unsuccessful. The prospects for additional office development on the balance of the Site are therefore highly unlikely. The one use that is not in the immediate area currently is a new, high-quality, luxury multi-family community.



Adding a luxury multi-family community in the context of the existing uses would be an enhancement not only to the housing options in the area but would also help support the retail uses in the center.

II. DEVELOPER BACKGROUND

Wood Partners is a best-in-class national institutional multi-housing real estate development firm with a significant presence in the Phoenix market as well as the City

of Chandler. Since 2011, the firm has been annually recognized as a "Top 5" real estate development firm in the United States by multiple publications. In 2019, Wood Partners was ranked #7 largest commercial real estate development firm in the Phoenix MSA.

Wood Partners develops approximately 4,000-5,000 multifamily units across the United States annually. Wood Partners' current portfolio includes 52 properties with 13,895 units worth more than \$4.3 billion. The firm is led locally by two development partners, Todd Taylor and Clay Richardson, who live in Phoenix and are spearheading the subject development. These partners have produced numerous high-quality and highly recognizable projects throughout in the Valley going back to 2004. Among those projects include the 273-unit Alta San Marcos multi-housing community located one mile to the east of the subject development, near Downtown Chandler. Alta San Marcos was awarded the highly coveted and prestigious "2019 Real Estate Development Award" for 'Best Multifamily Project' in the state Arizona. In 2014, Wood Partners worked closely with the City of Chandler to develop the Alta Steelyard Lofts, a pioneering luxury Class "A" community on Frye Road, southeast of the City's municipal complex, that has proven to be major catalyst in making Downtown Chandler the vibrant, dynamic area it is today. Alta Steelyard Lofts brought not only a new look to multifamily housing in Downtown but added a luxury housing option that was within walking distance of the existing and future governmental, high-tech and entertainment uses in Downtown.

III. SITE, SURROUNDING AREA and EXISTING ZONING

The Site is comprised of three parcels, two of which are developed and one that is not. **See Exhibit 1, Aerial Context Map**. The northern portion of the Site is an approximately 20,000 sq. ft. of office, generally one-story in height. The undeveloped portion of the Site, at the northwest corner of Parklane and Commonwealth St., is 1.92 ac. in size. The Site is generally flat and bordered by Chandler Boulevard on the north, Parklane Boulevard on the east, and Commonwealth Street on the south. The property to the west is developed with offices.

The Site is designated on the City's General Plan as Neighborhoods. The Neighborhood designation allows urban residential (densities exceeding 18 dus/ac) to be considered within high-capacity transit corridors. Chandler Boulevard is designated on the City's Circulation Plan Map as a high-capacity transit corridor. Consistent with the goals and objectives of the General Plan, rezoning the Site as an urban scale, multi-family residential community will:

- permit increased development and redevelopment intensity along this portion of the High Capacity Transit Corridor;
- complement and provide much needed support to the existing commercial and employment uses in the surrounding area; and
- promote sustainable housing developments including a variety of housing types and higher densities that are compatible with the adjoining land uses.

Existing Land Uses:	
North:	Office and commercial uses
East:	Commercial
South:	Multi-family
West:	Office

Existing	Zoning:
North:	C-3
South:	PAD MF
East:	PAD Commercial
West:	PAD Office

IV. PROPOSED PAD AMENDMENT, PDP and MR OVERLAY

A. Planned Area Development (PAD) and Mid-Rise (MR) Overlay

One of the objectives of PAD zoning is "to provide for a coordinated and compatibly arranged variety of land uses through innovative site planning." Another objective is "to provide a maximum choice in the types of environments for residential, commercial, and industrial uses and facilities." The intent of this PAD is to accomplish those objectives by rezoning the Site from the existing PAD to PAD Multi-Family Residential. The proposed zoning change responds to the existing and future needs of the community by providing support to the planned and existing commercial, office, and retail developments in the area and provides additional housing choices for people seeking to live in an urban, infill setting. The proposed PAD Multi-Family Residential accomplishes the PAD zoning objectives.

Wood Partners is requesting a Mid-Rise Overlay for the proposed approximate 63-foot building height. The additional height above the City's 45-foot requirement is necessary to provide for additional architectural articulation along the roofline including tower elements, varying heights in the parapets, and mechanical screening. The building height to the deck line of the roof is 43 feet. Consistent with the City's Mid-Rise Development Policy (the "Policy"), the additional height is appropriate as the Site is located near Downtown in the Chandler Boulevard high capacity corridor. Additionally, the proposed redevelopment of an infill site with the proposed use is compatible with and supports the existing commercial and employment uses in the area.



B. Preliminary Development Plan (PDP)

Wood Partners proposes to build a context appropriate Class A apartment community consisting of (3) three distinctive 4-story buildings with (293) multi-family residential units that are a mix of 1-, 2-, and 3- bedrooms units. **See Exhibit 2, Perspectives and Exhibit 3, Preliminary Site Plan.** The 1-bedroom units generally range in size between approximately 714 - 886 square feet; the 2-bedroom units between approximately 1,081 - 1,372

square feet; and the 3-bedroom units are approximately 1,409 square feet.

The buildings will line the adjacent perimeter streets, and actively engage both Chandler Boulevard and Parklane Boulevard with sidewalk connections from the ground floor units to the public sidewalk. Two buildings also define the development's north and east property lines.

A primary focus of Alta Chandler at the Park is to create an enhanced streetscape with curb appeal. Through discussions with Planning Staff, a generous setback for this type of development in an urban-like setting is provided on Chandler Boulevard (a minimum of 10 feet to the property line and 29 feet to the curb) and Parklane Boulevard (a minimum of 10 feet to the property line and 16 feet to the curb) that will be lushly landscaped.



The main pedestrian entry at the northeast corner of the site creates a strong sense of arrival, inviting visitors in through an "Outdoor Room". This Outdoor Room (see the adjacent perspective) continues an uninterrupted expanse of landscape and hardscape from the adjacent setback areas.

This primary building entry will be dramatic, with the doors surrounded

by glass storefront, architectural detailing at the ceiling, and views through the building out to the pool area. Access to street-side dwelling units is provided via individual sidewalks to private patios.

Sidewalks are provided throughout the Site to enable residents to easily access the public sidewalks leading to the adjacent, existing uses in the area and the bus transit stop just to the east on Chandler Boulevard. The public sidewalk on Chandler Boulevard will be detached from the curb and shaded with trees to enhance the pedestrian experience.



Perimeter gates carry the development's contemporary design theme and define the vehicular entries off Parklane Boulevard and Commonwealth Street. A bike shop and dog spa are strategically located at the southeast corner of the Site for the residents' use, tying resident uses to the pedestrian crosswalk across Parklane Boulevard.

1. Landscaping

Much thought and care has gone into landscaping to provide residents a rich and fulfilling lifestyle at Alta Chandler at the Park. **See Exhibit 4, Conceptual Landscape Plan**. Landscaping for Alta Chandler at the Park is proposed to feature a contemporary low water use landscape environment. The trees will be a mix of evergreen and deciduous, native and non-native species. Evergreens are provided to create a sense of place and scale, while deciduous trees will create a variety in color and texture as the seasons change. The landscape will be watered through an automatic drip irrigation system, to ensure maximum water conservation.

2. Amenities



The primary amenities and activity areas for Alta Chandler at the Park include the clubhouse, the leasing offices, the conference/business center, gourmet kitchen area, lounge area, cyber-cafe, and state-of-the-art fitness center. **See Exhibit 5, Amenity Plan**. These spaces then transition into the outside amenity area.

Expansive stretches of glass provide views looking west out to the pool deck and flood these spaces with light. Residents will enjoy activities such as cooking demonstrations, TVs, and recreational-type amenities such as a pool tables, game areas and

inter-active video game stations or just relax within the various lounge areas.

The centralized and appropriately sized open space will accommodate pedestrian amenities such as benches, shade trees, aesthetic paving treatments to encourage pedestrian use and connectivity to various facilities on the site. Outdoor common amenities are located in a distinctive oversized courtyard, with a pool, a heated spa for cooler temperatures, sunbathing deck, and ample covered patio areas and shaded areas near the outdoor pool to enjoy temperate weather out of the sun. Cabanas will act as outdoor rooms and complement the community's architecture and will be places for socializing, relaxing and contemplation. Bicycle racks and storage for the residents' use are located on-site and within the first floor of the buildings. A more detailed list of amenities is provided in Section V.3 below.

3. Building Architecture

The buildings' architectural theme has a warm contemporary feel, the use of a white and light tan color palette, metal railings, canopy projections with brackets, light multicolored brick and white stacked stone add visual interest. See Exhibit 6, Building Elevations; Exhibit 7, Floor & Roof Plans; and Exhibit 8, Color & Materials Palette. All of these elements will tie together with the architectural imagery to provide a strong identity for a site situated along one of Chandler's most significant thoroughfares.

Varied roof lines with metal canopy projections with brackets and stucco clad cornices create a signature appearance from both the street and internal vistas within the development. Different types of living space openings create variation on the elevations through covered balcony projections and metal railings. The brick and stacked stone supplement the architectural character and provide material texture to multiple building stories.

The southern portions of Buildings 2 & 3 are articulated with stepped parapets and lowered stair enclosure massing to mitigate any potential impact on the existing developments south of the Site. See the below perspective. The light complementary color scheme infuses the buildings with additional diversity by highlighting key architectural features and massing. The ground floor of these two buildings will have non-residential uses including a dog spa, bike shop, maintenance shop, and trash room.



Additionally, these two buildings are separated from the existing multi-family development south of the Site by approximately 85 ft. between the nearest proposed building to existing parking canopy and approximately 155 ft. between the nearest proposed building and existing building. In between the multi-family buildings will be landscaping, a public street (Commonwealth Street), additional landscaping, 1-story parking canopies, parking, a drive aisle, and landscaping.



4. Site Circulation and Parking

Primary access to the Site will occur through the main entrance from Parklane Boulevard. Secondary exit only/emergency access will be from Commonwealth Street. Appropriate circulation is provided throughout the Site for residents and guests through internal drives that allow residents and guests to park in close proximity to their residence. Where appropriate, designated pedestrian paths are provided through the parking areas. **See Exhibit 9, Circulation Plan**. As previously discussed, detached sidewalks are located along the perimeter streets.

Alta Chandler at the Park will contain 461 parking spaces (where 498 are typically required in a suburban setting). These parking spaces consist of 186 covered parking spaces, 108 enclosed private garage spaces, 108 tandem parking spaces, and 7 uncovered parking spaces, and 52 guest parking spaces. In addition to the on-site parking spaces, there are approximately 23 parking spaces along Parklane Boulevard and Commonwealth Street, bringing the total (on-site and off-site) number of parking spaces. The requested reduction for this urban-like development from suburban parking standards is a reduction of approximately 7.4% if the off-street parking spaces are not included and approximately 2.8% if they are included. Under either scenario, the reduction is appropriate when considering the following:

- Approximately 62% of the units are 1-bedrooms.
- The Site is adjacent to one of two designated high-capacity transit corridors.
- Institute of Transportation Engineers (ITE) Parking Generation parking demand for this development is only 361 parking spaces, which is a 27.7% surplus (100 spaces).
- Two comparable properties (Olympus Steelyard and the Met at Fashion Center) were recently approved by the City with even higher reduction rates of up to 7.5%.
- Overnight parking data was collected at these two properties (above) which showed there is no shortage of parking, in fact there was a parking surplus of 14%-17%.
- The proposed 7.4% reduction rate (without the on-street parking) is consistent with other multi-family developments that have been approved in the City.

A separate parking study has been prepared and was separately submitted to City Staff with additional details/justifications to support the requested parking reduction.

Additionally, a ride sharing loading zone will be built as part of this development and will be located outside the entry gate. It is anticipated that electric car charging stations will be constructed. The location will be identified during construction phases. Each resident will receive one parking permit per lease holder and per car. The parking permits will be color coded to identify cars allowed to use the carport parking and cars only permitted to use the garage.

C. Development Standards

Wood Partners is proposing the following development standards:

Regulation	Development Standard		
Building Height (max.)	43 ft. to the roof deck line		
	63 ft., inclusive of architectural elements, parapet walls, mechanical equipment,		
	and screening		

Building Setback (min.)	
- North	10 ft., 29 ft. to the curb
- East	10 ft., 16 ft. to the curb
- South	10 ft.
- West	10 ft.
Landscape Setback (min.)	
- North	10 ft., 29 ft. to the curb
- East	10 ft., 16 ft. to the curb
- South	10 ft.
- West	10 ft.

Arterial Street Intersection Landscape Setback (Sec. 35-1902(4)(a)(2)(a)). Under this provision, a landscape setback of 50 ft. x 100 ft. is required along Chandler Boulevard. Wood Partners requests Building 1 encroach into the required intersection landscape setback along Chandler Boulevard by approximately 33 feet. The encroachment is requested to allow Wood Partners to create a development with a more urban feel at this arterial/collector intersection in the Chandler Boulevard Corridor near Downtown. Wood Partners has worked to create a dynamic streetscape though the use of landscaping and building placement that is visually diverse and pleasing to residents and passers-by. Buildings along the street frontages contain various architectural details that allow them to create a more contemporary and urban edge. Additionally, the intersection of Chandler Boulevard and Parklane Boulevard has been enhanced visually through striking vertical architectural features, a pedestrian entry plaza, signage and structured landscape.

D. Miscellaneous

The **Wall Plan and Elevations** is attached as **Exhibit 10**.

The **Preliminary Grading and Drainage Map** is attached as **Exhibit 12**. The Site will be graded to convey storm water to the project retention basins. All project drainage systems will be designed and constructed per City standards.

V. <u>MULTI-FAMILY DESIGN STANDARDS</u>

The City's Zoning Ordinance sets forth additional requirements for multi-family development to encourage creative and innovative design techniques, quality and merit. Alta Chandler at the Park provides the following:

1. Open Space

The requirements for common and private open space are based on traditional suburban development and do not take into account developing in an urban-like setting. Wood Partners has taken great efforts to ensure the usable common open space far exceeds what the City's Code would otherwise require. The amenities throughout the development and within the common open spaces in this urban-like setting provide better opportunities for residents and guests to interact with each other. Approximately 42,000 square feet of usable common open space and 20,000± square feet of private

open space is provided, a total of approximately 62,000 square feet or 211.6± square feet per unit.

2. Site Circulation and Parking

Safe and convenient pedestrian circulation to and from parking lots throughout the development is provided. A detached sidewalk is located on arterial streets with public sidewalk access. The central area contains parking spaces that are a minimum of 9' x 19', with ADA van accessible spaces being 11' x 19'. Parking canopy covers will be architecturally integrated with the surrounding structures.

3. Amenity Options

Six amenities are required to be provided in accordance with the following schedule: 260 units or larger. The proposed development contains approximately 12 amenities which is double the required number of amenities. The amenities that have been provided throughout the development exceed the industry standards for quantity and quality of amenities in most multifamily developments. The amenities provided include:

- Pool with alcove seating nodes and baja shelf
- Heated spa
- Private covered cabanas
- Open deck lounge space
- BBQ's with Festoon Lighting
- Shaded Dining area
- Fireplace with lounge seating
- Artificial turf game lawn
- Outdoor ping pong tables
- Private fire pit nodes and seating area throughout
- Private gated dog park
- Bike racks and bike parking
- Ride share service parking

In addition to the above-listed amenities, Alta Chandler at the Park will have a bike shop and dog spa. The bike shop's location (at the southeast corner of the Site) is situated for easy access, with a door at first floor corridor of Building #2, and exterior access to and from Commonwealth Street. Equipped with inspection and repair stands, support brackets, built-in tables with stools, and ample glazing for natural light and views, this amenity space is also intended to activate the street corner with pedestrian and bike rider activity. For bike riding visitors arriving to the community, a bike rack will be located prominently at the main project entrance at the corner of Chandler and Parklane Boulevards.

The dog spa is located next to the bike shop. The dog spa will be outfitted with a wash station, tables and benches for sitting, drying and pampering. The space will be clad in durable tile surfaces and awash in natural light, with glazing that faces Parklane Boulevard. As with the bike shop, residents can access this amenity from the interior first floor corridor of Building 2, and through an exterior door with a covered entry that leads to and from the street.

4. Interface with Single-Family Areas

There are no single-family areas adjacent to the Site.

5. Specific design attention areas

The design of courtyards and pedestrian areas will relate to "human scale." Large unvaried building facades will be avoided. Common open spaces, rather than parking lots, will be used as central features. The specific design features incorporated into the design of the development are embraced by Wood Partners as design elements that set their communities apart from other multi-family developments.

6. Energy conservation

Alta Chandler at the Park provides shade of the buildings through overhangs and/or trees and shade trees along drives, building perimeters, and ample setbacks. Additional building shading is provided through the use of inset patios and balconies, recessed windows, metal canopies to shade windows, and the use of landscaping.

7. Landscaping

The amount of landscaping is of sufficient intensity to create a pleasant and comfortable living environment. The density of plant material is dependent on the mature size of the vegetation and the shape and size of the areas to be landscaped. The landscape palette is comprised of low-water use, desert native or adaptive materials that blend seamlessly and accentuate the architecture of the building design.

8. Building Standards

Mechanical equipment is fully screened through the use of parapet walls on the building elevations; they are concealed from view as an integral part of the building.

9. Lighting

Lighting will comply with the City's Zoning Code. External lighting will be appropriately located and designed to prevent light from spilling onto adjacent properties.

10. Signage

While paying respect to the character area of the "The Park" Wood Partners has proposed a corner monument that provides a modern twist to the corner monumentation. Painted steel, halo lit lettering, and stone veneer walls matching the proposed architectural character help blend the existing character with the new. **See Exhibit 11, Monument Sign and Site Details**.

VI. CONCLUSION

The existing office building on this Site was the first phase of the original PAD master plan. Although superbly maintained, this office building has suffered a lack of tenancy over the past years. All attempts to market the Site, as well as to construct additional office on the vacant 1.92 acres to the south have been unsuccessful and the existing office is no longer viable. Adding a new, luxury rental housing component, which is not currently available in the immediate area, will be a needed and compatible addition to the master plan that will support the retail, office and commercial uses in the area.


EXHIBIT 1







EXHIBIT 2

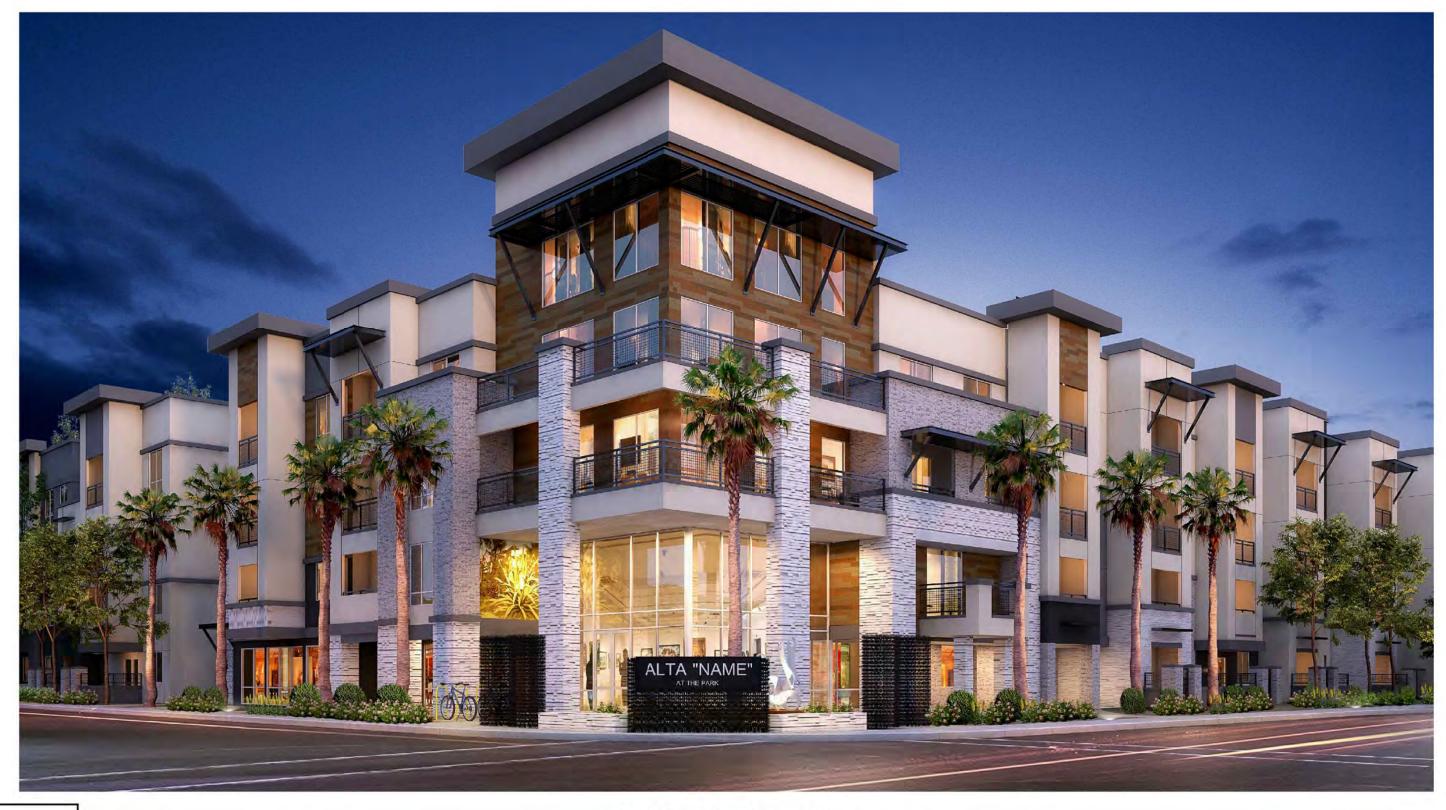

tform

CLUBHOUSE AND

ALTA CHANDLER AT THE PARK

WOOD PARTNERS

WALL/SIGNAGE

PERSPECTIVE

preliminary not for construction






PARKLANE AND COMMONWEALTH INTERSECTION

ALTA CHANDLER AT THE PARK

WOOD PARTNERS

PERSPECTIVE

preliminary not for construction

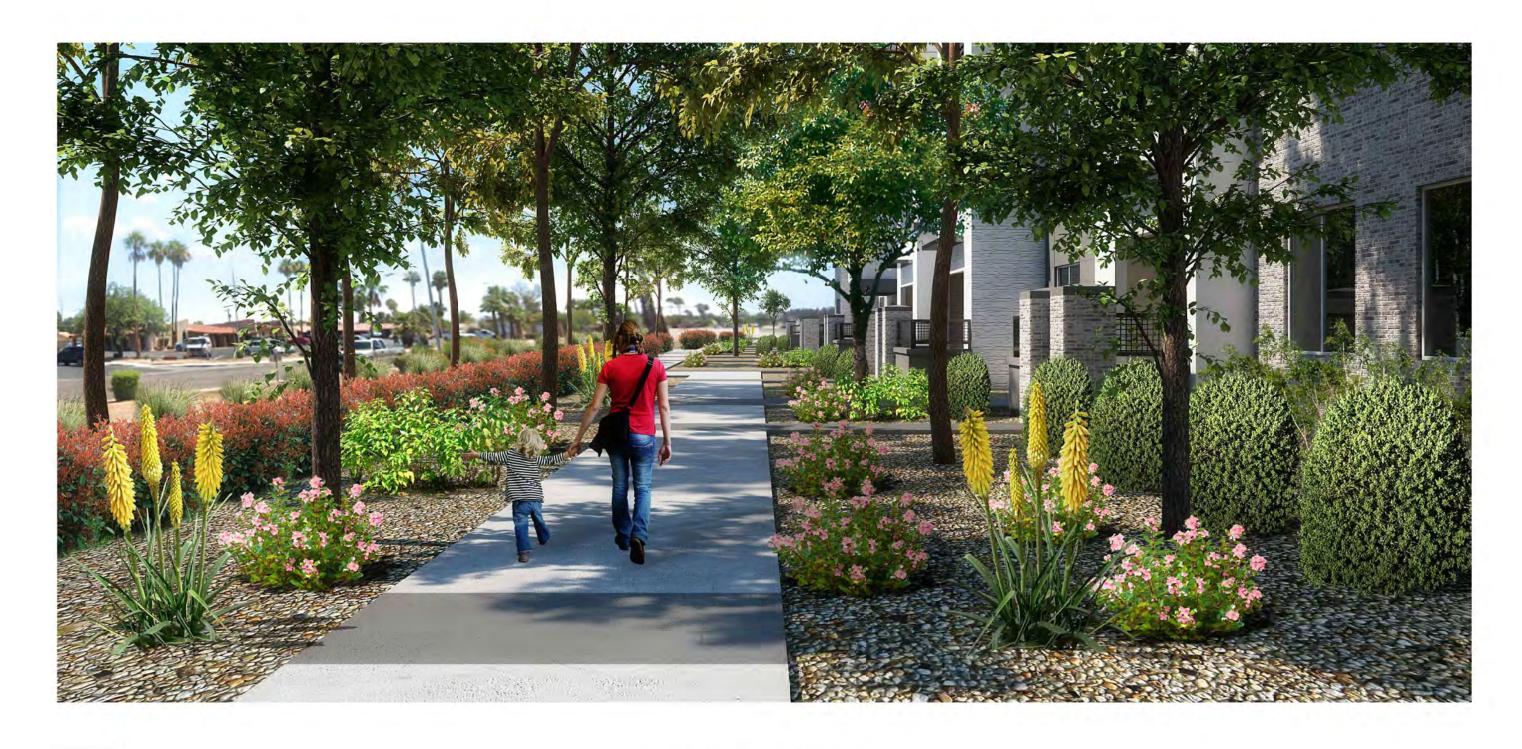

biltform architecture TYPICAL SIDEWALK ALONG CHANDLER BLVD

ALTA CHANDLER AT THE PARK

WOOD PARTNERS

PERSPECTIVE

preliminary not for construction

biltform architecture group, inc. 1460 north cave creek road . suite 11 phoenix . arizona 85020 Phone 602.285.9200





VEHICULAR ENTRY
PARKLANE BLVD MAIN ENTRANCE

ALTA CHANDLER AT THE PARK

WOOD PARTNERS

10/02/2020

PERSPECTIVE

preliminary not for construction

biltform architecture group, inc. 11460 north cave creek road . suite 11 phoenix . arizona 85020 Phone 602.285,9200





PARKLANE BLVD AND CHANDLER BLVD INTERSECTION

ALTA CHANDLER AT THE PARK

WOOD PARTNERS


10/02/2020 RSPECTIVE


PERSPECTIVE

preliminary not for construction

11460 north cave creek road . suit phoenix . anzona 85 Phone 602,285.9

EXHIBIT 3

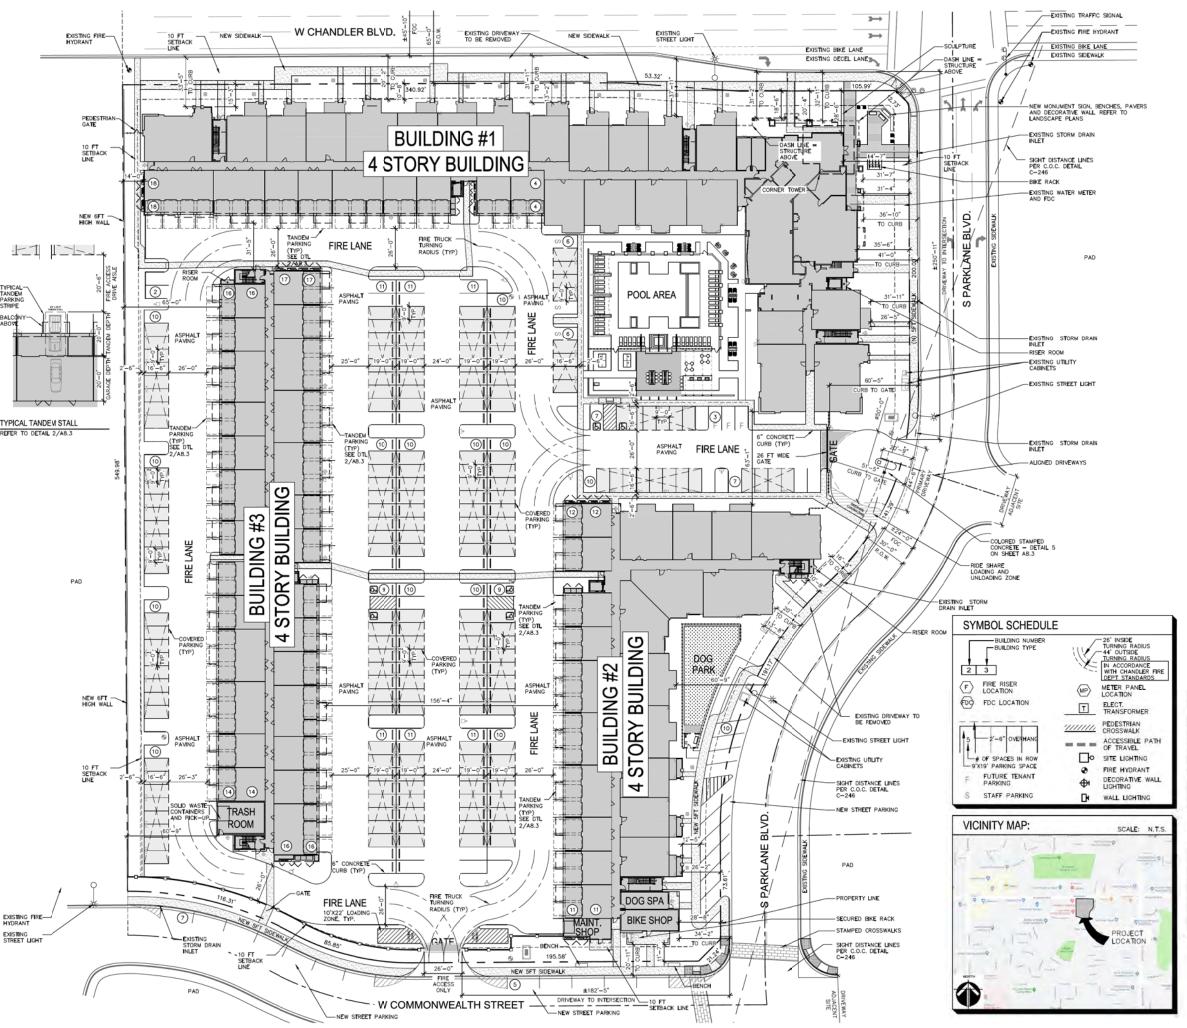

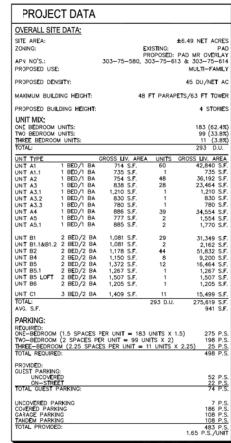

PROJECT NARRATIVE

- . 11 THREE-BEDROOM UNITS 1,409 SQUARE FEET; AND

THERE WILL BE QUALITY AMENITIES PROVIDE ON-SITE AT THE PROJECT CLUDING COVERED AND GARAGE PARKING OPTIONS, A RESORT STYLE POOL ON AN AMENITIZED CLUBHOUSE.


THE PROJECT WILL PROVIDE 469 PARKING STALLS, INCLUDING TANDEM PARKING (108), ENCLOSED GARAGE (108), COVERED PARKING (186), UNICOVERED (57) AND STREET (10) PARKING SPACES THAT WILL BE EVENLY DISTRIBUTED ACROSS THE PROJECT.

. ALL SITE IMPROVEMENTS, INCLUDING LANDSCAPING AND SITE CLEAN-UP MUST BE COMPLETED PRIOR TO CERTIFICATE OF OCCUPANCY FOR ANY BUILDING WITHIN

IN THE FIRE DEPARTMENT DOUBLE CHECK ASSEMBLY SHALL BE PAINTED TO MATCH ADJACENT WALL COLOR.

THE PROJECT WILL CONTAIN FOUR CAR CHARGING STATIONS. LOCATIONS TO BE TERMINED DURING CONSTRUCTION DOCUMENT PHASE.

ELECTRICAL METER PACKS TO BE RECESSED AND FULLY SCREENED, SES

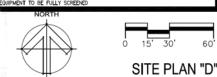

J 0 p

biltform architecture group, LLC.

11460 north cave creek road , sulte 11 phoenix , arizona 8 5 0 2 0 Phone 602.285.9200 Fax 602.285.9229

PREIMINARY CONSTRUCTION

AZ. 85258

lα

ш

RTN 201, Sco

PAI ₹

0

Ŏ

Via De Ventura,

폿

PA

ш

王

⋖

ш

CHANDL

⋖

₹

THE INTENT OF THIS PROJECT IS TO DEVELOP A MULTI-FAMIL CLASS "A" (LUXURY) APARTMENT COMMUNITY, WITH A TOTAL OF 293 APARTMENT HOMES. SPECIFICALLY, THE DEVELOPMENT'S CURREN CONCEPT INCLUDES:

- 99 TWO-BEDROOM UNITS RANGING FROM APPROXIMATELY 1,15 SQUARE FEET TO 1,507 SQUARE FEET;

AS CURRENTLY PLANNED THERE WILL BE ONE (1) PRIMARY ACCES: POINT FOR THE PROJECT LCCATED ALONG WEST PARKLAND BLVD. JUS' SOUTH OF WEST CHANDLER BLVD. A SECONDARY ACCESS WILL BE PROVIDE ALONG WEST COMMONWEALTH AVENUE.

SITE PLAN NOTES

2. ALL ROOF MOUNTED MECHANICAL EQUIPMENT SHALL BE FULLY SCREENED BY MAKAPET WALLS EQUAL TO, OR GREATER THAN, THE HIGHEST POINT ON THE MECHANICAL EQUIPMENT.

SIGNS REQUIRE A SEPARATE PERMIT.

THERE SHALL BE NO OBSTRUCTION OF SITE SIGNACE BY LANDSCAPE PLANT INDIRIAL AND THAT SUCH MUST BE RELOCATED/CORRECTED BEFORE THE FIELD BEPECTION WILL ACCEPT/PASS THE SIGN IN THE FIELD OR ISSUE A CERTIFICATE OF COUPANCY FOR THE PROJECT.

IL TRANSFORMER BOXES, METER PANELS AND ELECTRIC EQUIPMENT, BACK-FLOW DEVICES AND ANY OTHER UTILITY EQUIPMENT, NOT ABLE TO B SCREENED BY LANDSCAPING OR VALLS SHALL BE PAINTED TO MATCH THE

IÖ, GUEST PARKING IS PROVIDE AROUND THE ENTIRE SITE AT ANY UNCOVERED PÄRKING SPACE. ADDITIONAL SPACES ARE PROVIDED OFFSITE ON PARKLANE BLV

RIDE SHARE LOADING ZONE PROVIDED AT THE MAIN ENTRY GATE

REZONE RESUBMITTAL 10/02/2020

REVISIONS:	
<u>^</u> -	
<u>^</u> -	
<u>3</u> -	
<u></u>	
<u>\$</u>	
JOB NO:	19-0
SCALE:	1"=

A1.1

© BILTFORM ARCHITECTURE GROUP, INC

EXHIBIT 4















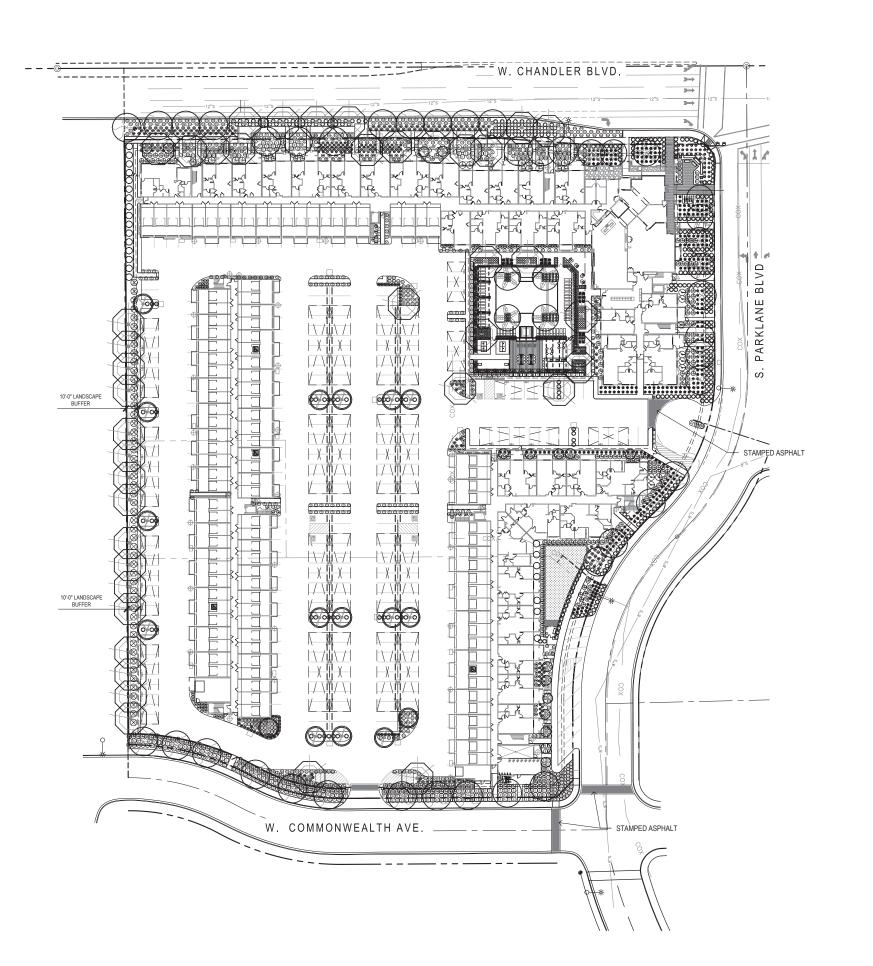

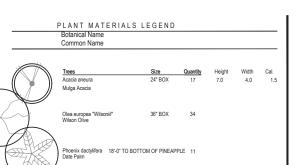


1	Wilson Olive		
	Phoenix dactylifera 18'-0" TO BOTTO Date Palm	OM OF PINEAPPL	E 11
	Pistacia lentiscus Mastic Tree	15 gal.	19 6.0
	Quercus virginiana 'Cathedral' Oak	24" box	44
	Extra Large Shrubs	Size	Quantity
	Cordia Boissieri Anachuita	5 gal.	23
\otimes	Dodonea viscosa Hopbush	5 gal.	51
⊕	Nerium oleander 'Petitie Pink' Pink Oleander	5 gal.	314
\odot	Tecoma alata 'Orange Jubilee' Orange Jubilee	5 gal.	9
_	Large Shrubs	Size	Quantity
(af-)	Simmondsia Chinensis 'Vista' Compact Jojoba	5 gal.	17
	Medium Shrubs	Size	Quantity
•	Eremophila glabra spp. caranosa-Winti Winter Blaze Eremophila hygrophana	er Blaze 5 gal.	109
E	Blue Bells Small Shrubs	5 gal. Size	283 Quantity
60	Bougainvillea 'Alexandria' Alexandra Bougainvillea	5 gal.	32
•	Buxus microphylla japonica Green Beauty Boxwood	5 gal.	293
	Groundcovers	Size	Quantity
▣	Eremophila prostrata 'Outback Sunrise Outback Sunrise Eremophila	1 gal	302
\odot	Lantana sp. 'New Gold' Lantana	1 gal.	231
0	Teucrium chamaedrys prostratum Prostate Germander	1 gal.	381
	Cacti/ Accents	Size	Quantity
Θ	Aloe hyb. 'Blue Elf' Blue Elf Aloe	5 gal.	145
•	Bouteloua gracilis Blond Ambition	5 gal	187
₩	Hesperaloe parviflora 'Brakelights' Red Yucca Portulacaria afra minima	3 gal.	56
Θ	Dwarf Elephant Food Yucca filamentosa	5 gal.	114
*	Adam's Needle Vines	5 gal Size	337 Quantity
	Trachleospermum Jasminoides	SIZE	
AD.	Dwarf Star Jasmine Inerts	5 gal	23 Quantity
No.	Decomposed Granite 1/2" Screened - 2	" DEDTU	51,668 SF.
No Symbol	Mahogany RockProsUSA	DEPIN	J1,000 SF.

Mahogany RockProsUSA

*all trees shall comply with the latest amended edition of the
Arizona Nursery Association - Recommended Tree Specifications.
see section 1903(6)(a), zoning code.

LANDSCAPE PLAN INFORMATION

Total Site Area	282,784 sf.	36.49 ac.
Total Building Area	96,409 sf.	34.09% of Total Site Area
Total Landscape Area	70,577 sf.	25.00% of Total Site Area
Total Parking Area	115,798 sf.	40% of Total Site Area
Landscape in Parking Area	11,579 sf.	10.00% of Total Parking Area
Total Turf Area	1,750 sf.	2.47% of Total Landscape Area
Shrubs Ground Cover	35,569 sf.	50.03% of Total Landscape Area
Inorganic/Granite	68,827 sf.	97.52% of Total Landscape Area

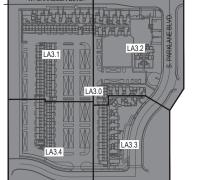





Not To Scale

1.5 0.5



Alta Chandler at the Park W. Chandler Blvd and W Parklane Blvd ^{Chnaler, AZ} Overall Planting Plan

Revisions

3

Issued for
■ Design Dev. 10.02.2020
□ Progress
□ City Submittal
□ Bid Set
□ Construction

Title


Overall Planting Plan

Scale Drawn By


Checked By Project Number

Permit Number

Sheet Number LA3.0

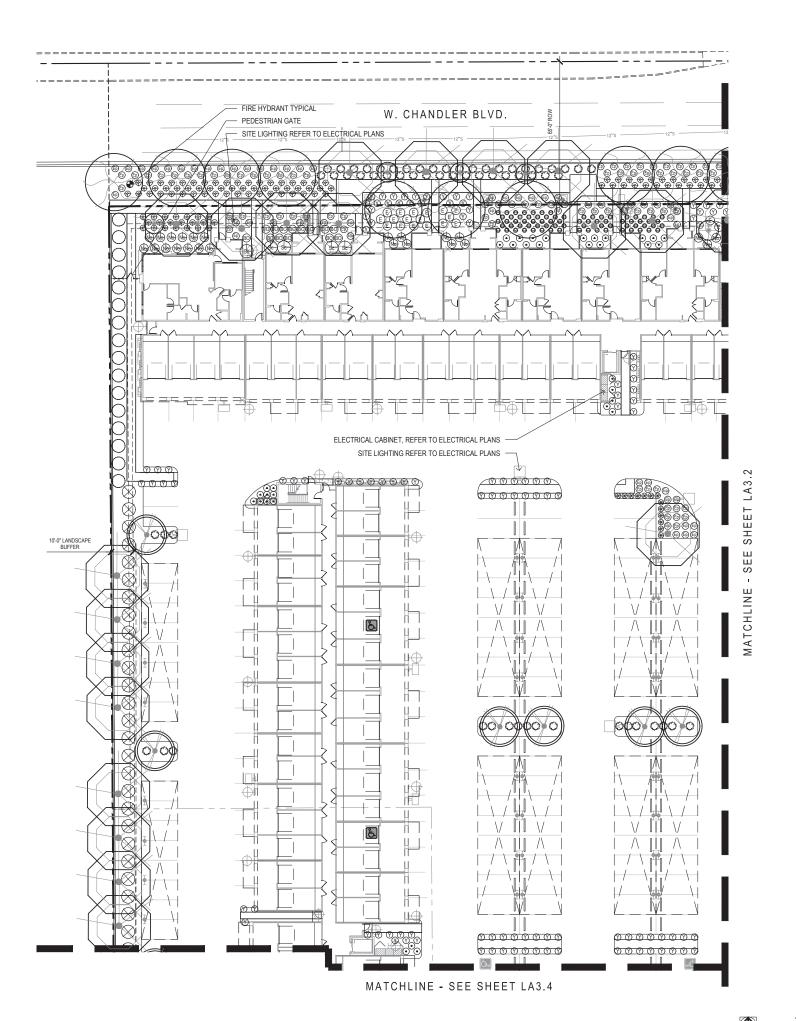

PLANT MATERIALS LEGEND

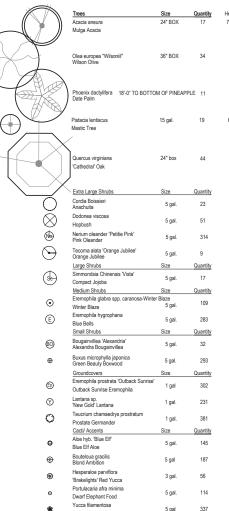


Inerts
Decomposed Granite 1/2" Screened - 2" DEPTH Mahogany RockProsUSA *all trees shall comply with the latest amended edition of the *Arizona Nursery Association - Recommended Tree Specifications' see section 1903(6)(a), zoning code.


Dwarf Star Jasmine

LANDSCAPE PLAN INFORMATION

otal Site Area	282.784 sf.	36.49 ac.
otal Building Area	96,409 sf.	34.09% of Total Site Area
otal Landscape Area	70,577 sf.	25.00% of Total Site Area
otal Parking Area	115,798 sf.	40% of Total Site Area
andscape in Parking Area	11,579 sf.	10.00% of Total Parking Area
otal Turf Area	1,750 sf.	2.47% of Total Landscape Area
hrubs Ground Cover	35,569 sf.	50.03% of Total Landscape Area
norganic/Granite	68,827 sf.	97.52% of Total Landscape Area

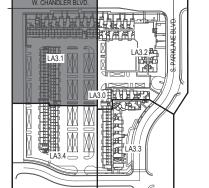



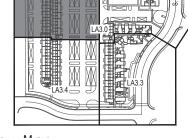

Key Map

Not To Scale

1.5 0.5

Alta Chandler at the Park W. Chandler Blvd and W Parklane Blvd ^{Chnaler, AZ} Planting Plan

Revisions

3

Issued for
Design Dev. 10.02.2020
Progress
City Submittal
Bid Set
Construction

Title


Scale

Drawn By

Checked By

Permit Number

Sheet Number LA3.1

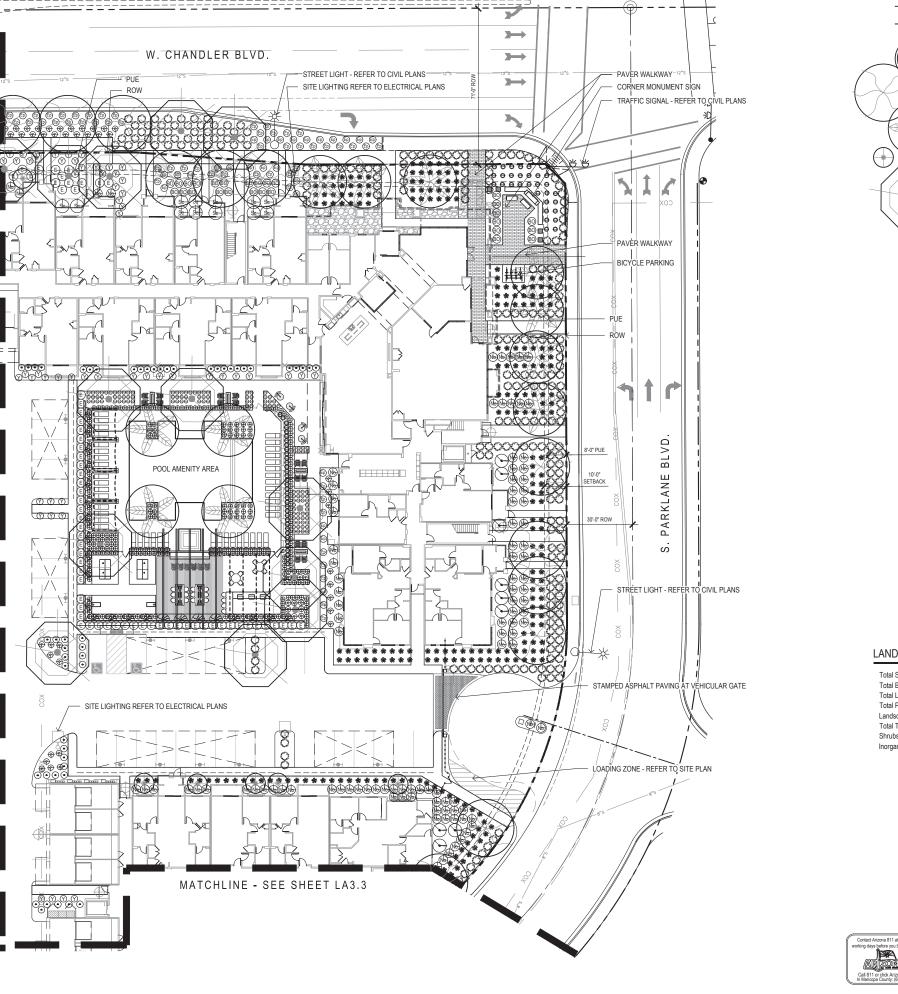


SHEET

- SEE

MATCHLINE

PLANT MATERIALS LEGEND

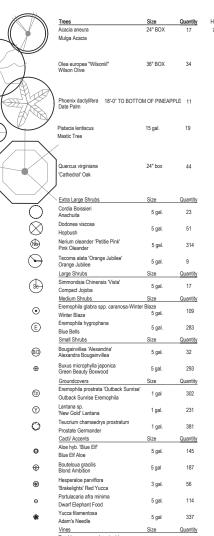


Inerts
Decomposed Granite 1/2" Screened - 2" DEPTH No Symbol Mahogany RockProsUSA *all trees shall comply with the latest amended edition of the *Arizona Nursery Association - Recommended Tree Specifications' see section 1903(6)(a), zoning code.

Dwarf Star Jasmine

LANDSCAPE PLAN INFORMATION

AD)

otal Site Area	282,784 sf.	36.49 ac.
tal Building Area	96,409 sf.	34.09% of Total Site Area
ital Landscape Area	70,577 sf.	25.00% of Total Site Area
tal Parking Area	115,798 sf.	40% of Total Site Area
ndscape in Parking Area	11,579 sf.	10.00% of Total Parking Area
tal Turf Area	1,750 sf.	2.47% of Total Landscape Area
rubs Ground Cover	35,569 sf.	50.03% of Total Landscape Area
organic/Granite	68,827 sf.	97.52% of Total Landscape Area

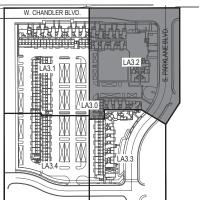



Not To Scale Key Map

1.5 0.5

W A Y 2 8 0 7 0 0 7 0 0 1

ᅐᅂᆼ

Blvd Alta Chandler at the Park W. Chandler Blvd and W Parklane I

Planting F

Revisions

3 Issued for
Design Dev. 10.02.2020
Progress
City Submittal
Bid Set
Construction

Title

10.02.2020 Scale


1" = 20'-0" Drawn By CH, CR


Checked By

Permit Number

Sheet Number


LA3.2

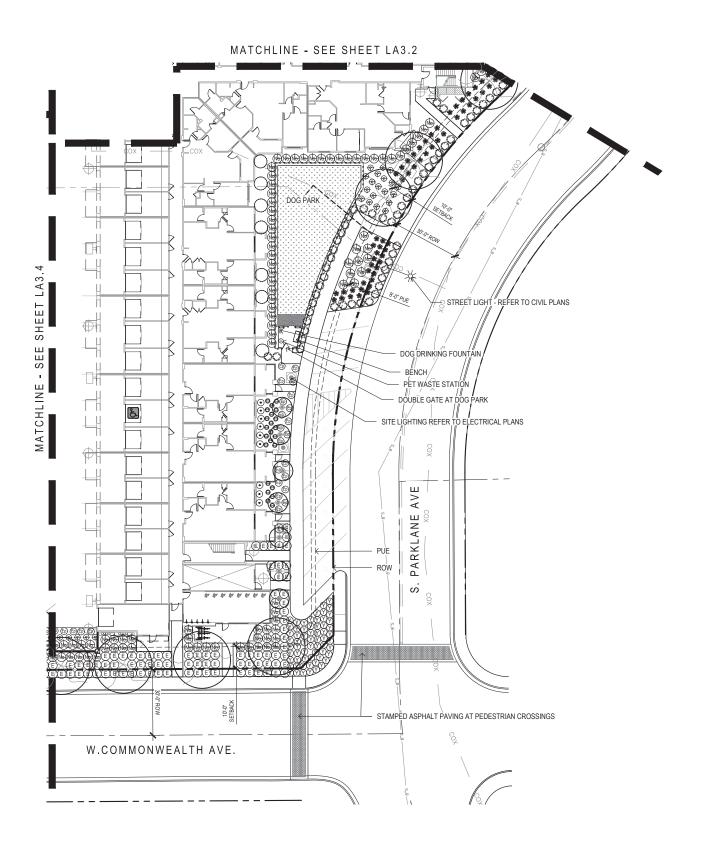

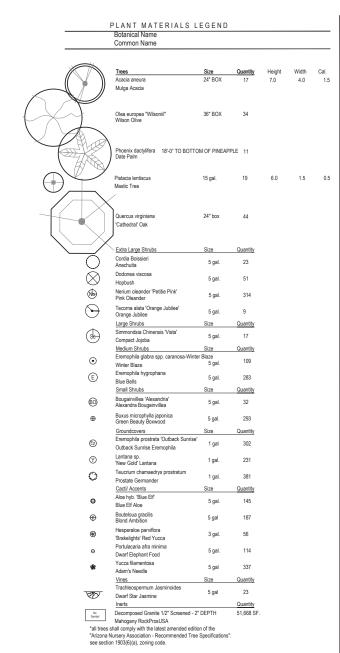



LANDSCAPE PLAN INFORMATION

Total Site Area	282,784 sf.	36.49 ac.
Total Building Area	96,409 sf.	34.09% of Total Site Area
Total Landscape Area	70,577 sf.	25.00% of Total Site Area
Total Parking Area	115,798 sf.	40% of Total Site Area
Landscape in Parking Area	11,579 sf.	10.00% of Total Parking Area
Total Turf Area	1,750 sf.	2.47% of Total Landscape Area
Shrubs Ground Cover	35,569 sf.	50.03% of Total Landscape Area
Inorganic/Granite	68,827 sf.	97.52% of Total Landscape Area

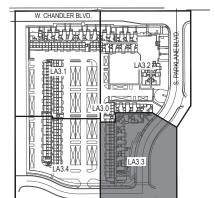



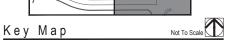

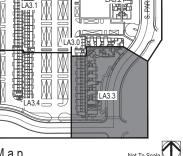



Alta Chandler at the Park W. Chandler Blvd and W Parklane Blvd ^{Chnaler, AZ} Planting Plan

Revisions

3

Issued for
Design Dev. 10.02.2020
Progress
City Submittal
Bid Set
Construction Title


10.02.2020 Scale


Drawn By

Checked By

Permit Number

Sheet Number LA3.3

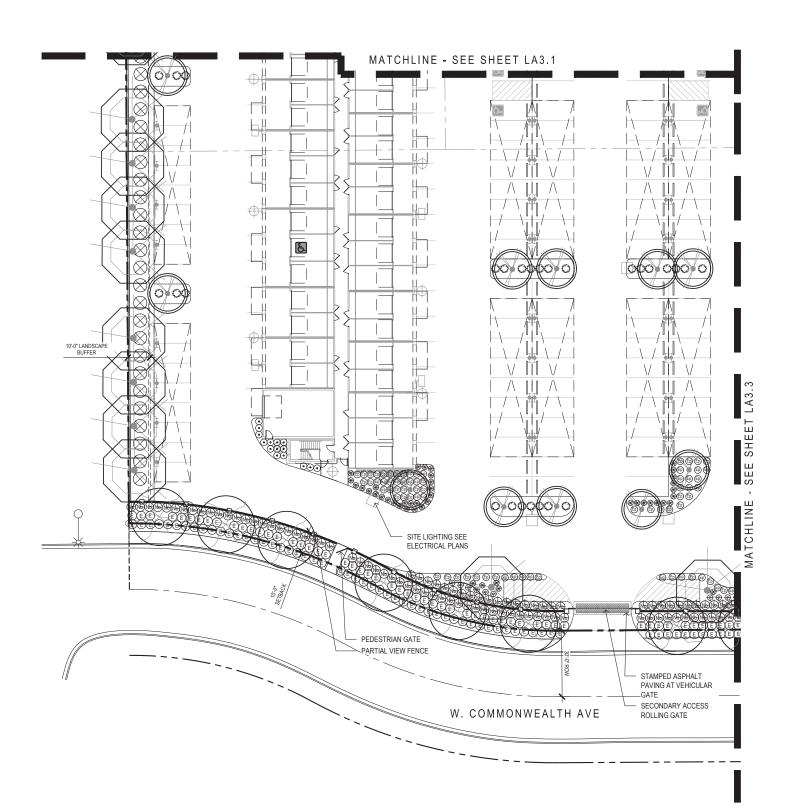

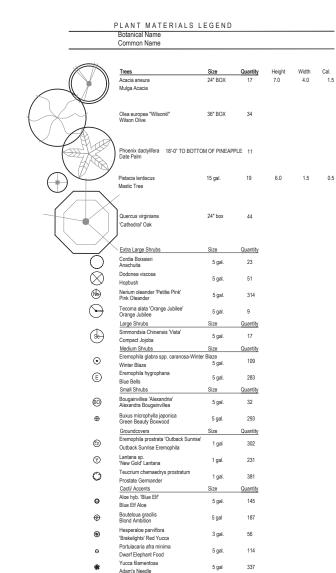


No Symbol

Dwarf Star Jasmine


LANDSCAPE PLAN INFORMATION

B

Total Site Area	282,784 sf.	36.49 ac.
Total Building Area	96,409 sf.	34.09% of Total Site Area
Total Landscape Area	70,577 sf.	25.00% of Total Site Area
Total Parking Area	115,798 sf.	40% of Total Site Area
Landscape in Parking Area	11,579 sf.	10.00% of Total Parking Area
Total Turf Area	1,750 sf.	2.47% of Total Landscape Area
Shrubs Ground Cover	35,569 sf.	50.03% of Total Landscape Area
Inorganic/Granite	68,827 sf.	97.52% of Total Landscape Area

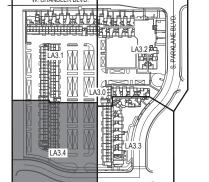



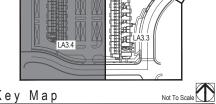

Key Map

2 8 0 7 C 0 7 ~ 10 0



Alta Chandler at the Park W. Chandler Blvd and W Parklane Blvd ^{Chnaler, AZ} Planting Plan

Revisions

3

Issued for
Design Dev. 10.02.2020
Progress
City Submittal
Bid Set
Construction

Title

10.02.2020 Scale

1" = 20'-0" Drawn By Checked By

Permit Number

Sheet Number LA3.4

EXHIBIT 5



KEYNOTES

- 1 POOL 2 SPA 3 CABANAS
- 4 RAMADA WITH OUTDOOR SEATING
- 5) OUTDOOR KITCHEN WITH FESTOON LIGHTS (6) PASSIVE SEATING AND CIRCULATION
- 7 PALM TREE PLANTERS
- 8 PING PONG
- 9 BEAN BAG
- 10 THEME WALL
- 11 LOUNGE SEATING
- 12 DINING AREA
- (13) FIRE PIT
- (4) GLASS POOL BARRIER
- 15 METAL POOL BARRIER









EXHIBIT 6



- . EXTERIOR STUCCO SYSTEM
- 2. STUCCO PARAPET CAP
- 3. FULLY SCREENED MECHANICAL UNITS BEYOND.
- 4. LIGHT FIXTURE
- 5. FOAM/STUCCO POP-OUT WITH SAND FINISH
- 6. WINDOW
- 7. METAL BALCONY RAILING 8. DOOR PER PLAN
- 9. STUCCO CONTROL JOINT 10. GARAGE DOOR
- 11. METAL RAILING
- 12. ALUMINUM STOREFRONT WINDOW SYSTEM 13. FRAMED BALCONY
- 14. ALUMINUM TELESCOPING DOOR SYSTEM
- 15. STONE VENEER
- 16. LOW WALL 17. METAL GATE
- 18. FIBER CEMENT SIDING
- 19. METAL CANOPY, PAINTED 20. BRICK VENEER
- 21. METAL GATE/ENCLOSURE FOR FULLY SCREENED ELECTRICAL EQUIPMENT

GENERAL ELEVATION NOTES:

Е - \Box 0 C q

biltform architecture group, LLC.

11460 north cave creek road . suite 11 phoenix . arizona 8 5 0 2 0 Phone 602 285 9200 Fax 602 285 9229

PREIMINARY CONSTRUCTION

PARTNERS Suite 201, Scottsdale, AZ. 85258

WOOD F

폿

 $\overline{\forall}$

 \Box

ш

王

⋖

Ш हैं

CHANDLE Apartine

 \triangleleft


F

ALL ROOF MOUNTED MECHANICAL EQUIPMENT SHALL BE FULLY SCREENED BY PARAPET WALLS EQUAL TO OR GREATER THAN, THE HIGHEST POINT ON THE MECHANICAL EQUIPMENT.

- MCCHANGAL EQUIPMENT,
 SOLID MASONRY WALLS AND GATES EQUAL TO, OR
 GREATER THAN, THE HIGHEST POINT ON THE
 MCCHANICAL EQUIPMENT SHALL SCREEN ALL GROUNI
 MOUNTED MECHANICAL EQUIPMENT.
- MOUNTED MECHANICAL EQUIPMENT.
 ANY ROOF ACCESS LADDERS SHALL BE LOCATED INSIDE THE BUILDING. ROOF DRAINAGE SHALL UTILL INTERIOR ROOF DRAINS OR BE ARCHITECTURY INTEGRATED INTO THE BUILDING DESIGN.
 ARCHITECTURALLY INTEGRATED FLOOR DRAINS SHAL REQUIRE ADDITIONAL ARTICULATION BEYOND PAINT ACCENTS. SECTION 35–1902 (8)(e)(15), ZONING CODE.
- . SIGNS REQUIRE A SEPARATE SUBMITTAL AND PERMIT ALL ROOF EQUIPMENT, HVAC, TRASH CHUTE AND ANY ELEVATOR VENTS, ETC. ARE TO BE BELOW THE LOWEST BUILDING PARAPET ELEVATION.

EXTERIOR COLOR SCHEME 1

EXTERIOR OOLOR DONEME 1.		
A LICHT STUCCO COLOR	BENJAMIN MOOI 2123-70 ICE MIST	
B MIDRANGE STUCCO COLOR	DUNN EDWARD DE6255 WSHING WELL	
C DARK STUCCO COLOR	DUNN EDWARD DE6327 RHINOCEROS	
D RAILINGS/CANOPIES /DOORS/ACCENT	DUNN EDWARD DEA187 BLACK	
E ROUGH TEXTURED FIBER CEMENT SIDING	DUNN EDWARD DE T681 MODERN CLAS	
F STONE VENEER	CORONADO SAWTOOTH LED WHITE	
G BRICK VENEER	SUMMIT FACE BE 702 TBL CONCORDE	
H WNDOW/STOREFRONT	WHITE	

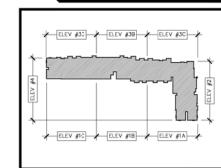

REZONE RESUBMITTAL 10/02/2020

<u>/1\</u> -	
∕2 -	
<u>3</u> -	
4 -	
<u>/</u> 5\	
JOB NO:	19-051
SCALE:	1/8" = 1'-0"
SHEET NO:	

A3.7C

BUILDING 1 - EXTERIOR ELEVATIONS



- EXTERIOR STUCCO SYSTEM
- STUCCO PARAPET CAP
- FULLY SCREENED MECHANICAL UNITS BEYOND
- LIGHT FIXTURE
- FOAM/STUCCO POP-OUT WITH SAND FINISH
- WINDOW
- METAL BALCONY RAILING DOOR PER PLAN
- 9. STUCCO CONTROL JOINT
- 10. GARAGE DOOR 1. METAL RAILING
- 12. ALUMNUM STOREFRONT WINDOW SYSTEM 13. FRAMED BALCONY
- 14. ALUMINUM TELESCOPING DOOR SYSTEM
- 15. STONE VENEER
- 16. LOW WALL
- 17. METAL GATE 18. FIBER CEMENT SIDING
- 19. METAL CANOPY, PAINTED 20. BRICK VENEER
- 21. METAL GATE/ENCLOSURE FOR FULLY SCREENED ELECTRICAL EQUIPMENT



biltform architecture group, LLC.

11460 north cave creek road , suite 11 phoenix , arizona 8 5 0 2 0
Phone 602.285.9200 Fax 602.285.9229

PREIMINARY CONSTRUCTION

PARTNERS Suite 201, Scottsdale, AZ. 85258

WOOD F. Via De Ventura, S.

퐀

⋖

Δ.

ш

폰

⋖

ш

CHANDL

⋖

₹

GENERAL ELEVATION NOTES:


- ALL ROOF MOUNTED MECHANICAL EQUIPMENT SHALL BE FULLY SCREENED BY PARAPET WALLS EQUAL TO, OR GREATER THAN, THE HIGHEST POINT ON THE MECHANICAL EQUIPMENT.
- SOLID MASONRY WALLS AND GATES EQUAL TO, OR GREATER THAN, THE HIGHEST POINT ON THE MECHANICAL EQUIPMENT SHALL SCREEN ALL GROUNI MOUNTED MECHANICAL EQUIPMENT.
- MOUNTED MECHANICAL EQUIPMENT.

 ANY ROOF ACCESS LADDERS SHALL BE LOCATED INSIDE THE BUILDING. ROOF DRAINAGE SHALL UTIL. INTERIOR ROOF DRAINS OR BE ARCHITECTURALLY INTEGRATED INTO THE BUILDING DESIGN.

 ARCHITECTURALLY INTEGRATED FLOOR DRAINS SHALL REQUIRE ADDITIONAL ARTICULATION BEYOND PAINT ACCENTS. SECTION 35–1902 (8)(e)(15), ZONING CODE.
- SCREENING SHALL BE ARCHITECTURALLY INTEGRATED SCREENING SHALL BE ARCHITECTURALLY INTEGRATE FOR THE SERVICE EXCITON (SSS) AND AL UTILITIES. ALL GROUND MOUNTED EQUIPMENT SHALL BE SCREENED FROM PUBLIC WEW BY A CONCRETE C MASCARY WALL WITH SOULD GATES, EQUAL TO OR GREATER IN HEIGHT THAN THE WECHANICAL EQUIPMENT. SECTION 35–1902 (8)(e)13, ZONING CODE.
- SIGNS REQUIRE A SEPARATE SUBMITTAL AND PERMIT ALL ROOF EQUIPMENT, HVAC, TRASH CHUTE AND ANY ELEVATOR VENTS, ETC. ARE TO BE BELOW THE LOWEST BUILDING PARAPET ELEVATION.

EXTERIOR COLOR SCHEME 1

A LIGHT STUCCO COLOR	BENJAMIN MOORE 2123-70 ICE MIST
B MIDRANGE STUCCO COLOR	DUNN EDWARDS DE6255 WISHING WELL
C DARK STUCCO COLOR	DUNN EDWARDS DE6327 RHINOCEROS
D RAILINGS/CANOPIES /DOORS/ACCENT	DUNN EDWARDS DEA187 BLACK
E ROUGH TEXTURED FIBER CEMENT SIDING	DUNN EDWARDS DET681 MODERN CLASS
F STONE VENEER	CORONADO SAWTOOTH LEDGE WHITE
G BRICK VENEER	SUMMIT FACE BRICK 702 TBL CONCORDE
H WINDOW/STOREFRONT /CARPORTS	WHITE

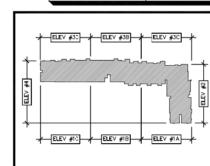

REZONE RESUBMITTAL 10/02/2020

1	7 -	
/2	7 -	
/3	7 -	
4	7 -	
<u>/s</u>	7	
JOE	3 NO:	19-0
SC	ALE:	1/8" = 1





1. EXTERIOR STUCCO SYSTEM

2. STUCCO PARAPET CAP

5. FOAM/STUCCO POP-OUT WITH SAND FINISH

7. METAL BALCONY RAILING

12. ALUMINUM STOREFRONT WINDOW SYSTEM 13. FRAMED BALCONY

14. ALUMINUM TELESCOPING DOOR SYSTEM

15. STONE VENEER

18. FIBER CEMENT SIDING

20. BRICK VENEER

PREIMINARY CONSTRUCTION

ALL ROOF MOUNTED MECHANICAL EQUIPMENT SHALL BE FULLY SCREENED BY PARAPET WALLS EQUAL TO OR GREATER THAN, THE HIGHEST POINT ON THE MECHANICAL EQUIPMENT.

SOLID MASONRY WALLS AND GATES EQUAL TO, OR GREATER THAN, THE HIGHEST POINT ON THE MECHANICAL EQUIPMENT SHALL SCREEN ALL GROUND MOUNTED MECHANICAL EQUIPMENT.

MOUNTED MECHANICAL EQUIPMENT.
ANY ROOF ACCESS LADDERS SHALL BE LOCATED
INSIDE THE BUILDING. ROOF DRAINAGE SHALL UTIL
INTERIOR ROOF DRAINS OR BE ARCHITECTURALLY
INTEGRATED INTO ITEM BUILDING DESIGN.
ARCHITECTURALLY INTEGRATED FLOOR DRAINS SHAL
RECORD REPORT OF THE ADDITIONAL ARTICULATION BEYOND PAYING
COCCUM. SECTION 35–1902 (8)(e)(15), ZONING
COCE.


SIGNS REQUIRE A SEPARATE SUBMITTAL AND PERMIT ALL ROOF EQUIPMENT, HVAC, TRASH CHUTE AND ANY ELEVATOR VENTS, ETC. ARE TO BE BELOW THE LOWEST BUILDING PARAPET ELEVATION.

EXTERIOR COLOR SCHEME 1 A LIGHT STUCCO COLOR

B MIDRANGE STUCCO COLOR C DARK STUCCO COLOR DUNN EDWARDS DEA187 BLACK D RAILINGS/CANOPIES /DOORS/ACCENT DUNN EDWARDS DET681 MODERN CLASS E ROUGH TEXTURED FIBER CEMENT SIDING

F STONE VENEER

G BRCK VENEER H WINDOW/STOREFRONT /CARPORTS

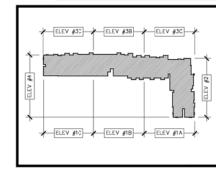

F REZONE RESUBMITTAL 10/02/2020

 \triangleleft

A CHANDLER AT THE PARI
Apartment Homes
Apartment Homes
WOOD PARTNERS
E. Via De Ventura, Suite 201, Scottsdale, AZ. 85258

Е

0 C

q

biltform architecture

group, LLC. 11460 north cave creek road . suite 11 phoenix . arizona 8 5 0 2 0 Phone 602 285 9200 Fax 602 285 9229

폿


-

⊐

ᅩ

2 4

A3.8C

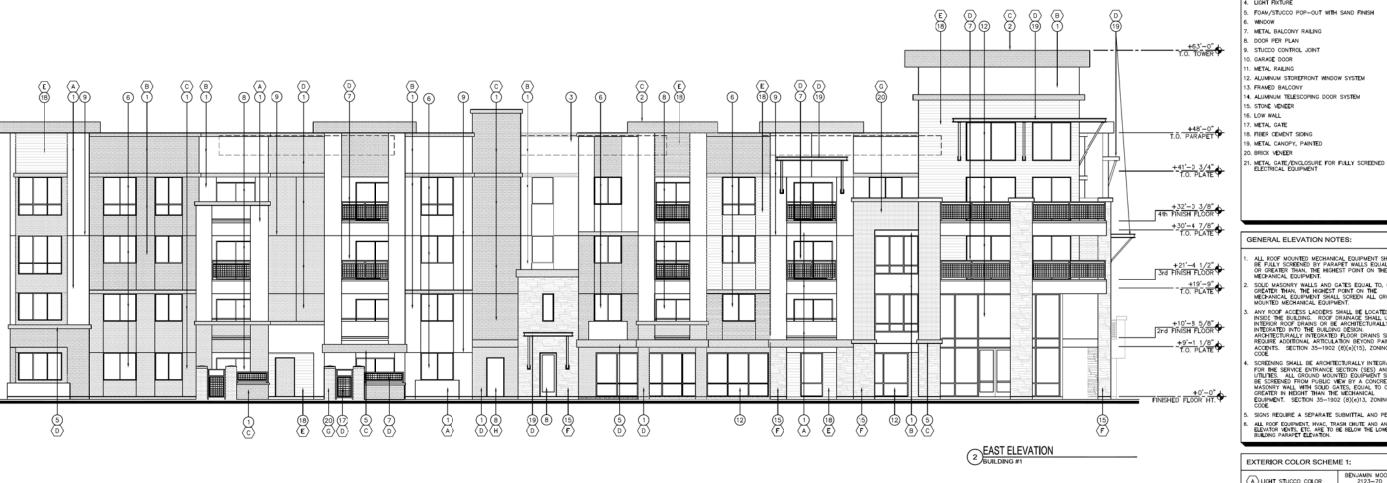



EXTERIOR STUCCO SYSTEM

STUCCO PARAPET CAP

FULLY SCREENED MECHANICAL UNITS BEYOND

LIGHT FIXTURE FOAM/STUCCO POP-OUT WITH SAND FINISH

METAL BALCONY RAILING

DOOR PER PLAN . STUCCO CONTROL JOINT

O. GARAGE DOOR

12. ALUMNUM STOREFRONT WINDOW SYSTEM

13. FRAMED BALCONY

14. ALUMNUM TELESCOPING DOOR SYSTEM

15. STONE VENEER 16. LOW WALL

18. FIBER CEMENT SIDING

20. BRICK VENEER

Е -ם 0 C p

biltform architecture group, LLC.

11460 north cave creek road , suite 11 phoentx , artzona 8 5 0 2 0 Phone 602.285.9200 Fax 602.285.9229

PREIMINARY CONSTRUCTION

PARTNERS
Suite 201, Scottsdale, AZ. 85258

WOOD F. Via De Ventura, S.

ARK

₽

ш

王

⋖

CHANDL

×

 $\frac{1}{4}$

Ш Бृ≝

GENERAL ELEVATION NOTES:

ALL ROOF MOUNTED MECHANICAL EQUIPMENT SHALL BE FULLY SCREENED BY PARAPET WALLS EQUAL TO, OR GREATER THAN, THE HIGHEST POINT ON THE MECHANICAL EQUIPMENT.

SOLID MASONRY WALLS AND GATES EQUAL TO, OR GREATER THAN, THE HIGHEST POINT ON THE MECHANICAL EQUIPMENT SHALL SCREEN ALL GROUNI MOUNTED MECHANICAL EQUIPMENT.

MOUNTED MECHANICAL EQUIPMENT.
ANY ROOF ACCESS LADDERS SHALL BE LOCATED
INSIDE THE BUILDING. ROOF DRAINAGE SHALL UTILE
INTERIOR ROOF DRAINS OR BE ARCHTECTURALLY
INTERIOR ROOF DRAINS OR BE ARCHTECTURALLY
INTERIOR ARCHTECTURALLY INTERRATED FLOOR DRAINS SHALL
REQUIRE ADDITIONAL ARTICULATION BEYOND PAINT
ACCENTS. SECTION 35—1902 (B)(e)(15), ZONING
COOE

SCREENING SHALL BE ARCHITECTURALLY INTEGRATED FOR THE SERVICE ENTRANCE SECTION (SES) AND ALL GROUND MOUNTED EQUIPMENT SHALL BE SCREENED FROM PUBLIC VIEW BY A CONCRETE ON MASCARY WALL WITH SOULD GATES, EQUAL TO OR GREATER IN HEIGHT THAN THE VECHANICAL COUNTY OF THE COMPARENT. SECTION 35–1902 (8)(e)13, ZONING CODE

SIGNS REQUIRE A SEPARATE SUBMITTAL AND PERMIT ALL ROOF EQUIPMENT, HVAC, TRASH CHUTE AND ANY ELEVATOR VENTS, ETC. ARE TO BE BELOW THE LOWEST BUILDING PARAPET ELEVATION.

EXTERIOR COLOR SCHEME 1: A LIGHT STUCCO COLOR

)	ICE MIST
B MIDRANGE STUCCO COLOR	DUNN EDWARDS DE6255 WISHING WELL
C DARK STUCCO COLOR	DUNN EDWARDS DE6327 RHINOCEROS
D RAILINGS/CANOPIES /DOORS/ACCENT	DUNN EDWARDS DEA187 BLACK
E ROUGH TEXTURED FIBER CEMENT SIDING	DUNN EDWARDS DET681 MODERN CLASS
F STONE VENEER	CORONADO SAWTOOTH LEDG WHITE

G BRICK VENEER H WINDOW/STOREFRONT /CARPORTS WHITE



ELEV #10 + ELEV #18 + ELEV #1A +

REZONE RESUBMITTAL 10/02/2020

REVISIONS: ҈ -<u> </u> -<u>∕</u>5\ JOB NO:

A3.8

BUILDING 1 - EXTERIOR ELEVATIONS

© BILTFORM ARCHITECTURE GROUP, INC.



- . EXTERIOR STUCCO SYSTEM
- 2. STUCCO PARAPET CAP
- 3. FULLY SCREENED MECHANICAL UNITS BEYOND.
- 4. LIGHT FIXTURE
- 5. FOAM/STUCCO POP-OUT WITH SAND FINISH
- 6. WINDOW 7. METAL BALCONY RAILING
- 8. DOOR PER PLAN 9. STUCCO CONTROL JOINT
- 10. GARAGE DOOR
- 11. METAL RAILING 12. ALUMINUM STOREFRONT WINDOW SYSTEM
- 13. FRAMED BALCONY
- 14. ALUMINUM TELESCOPING DOOR SYSTEM
- 15. STONE VENEER 16. LOW WALL
- 17. METAL GATE
- 18. FIBER CEMENT SIDING 19. METAL CANOPY, PAINTED
- 20. BRICK VENEER 21. METAL GATE/ENCLOSURE FOR FULLY SCREENED ELECTRICAL EQUIPMENT

group, LLC.

11460 north cave creek road . suite 11 phoenix . arizona 8 50 2 0 Phone 602 285 9200 Fax 602 285 9229

PRELIMINARY CONSTRUCTION

PARTNERS Suite 201, Scottsdale, AZ. 85258

WOOD F. Via De Ventura, S.

ш

폿

⋖

₾.

Ш

王

⋖

Ш हैं

CHANDLE

 \triangleleft

F

biltform architecture

Е

0 C

q

 \supset


GENERAL ELEVATION NOTES:

- ALL ROOF MOUNTED MECHANICAL EQUIPMENT SHALL BE FULLY SCREENED BY PARAPET WALLS EQUAL TO OR GREATER THAN, THE MECHANICAL EQUIPMENT.
- MCCIPANICAL EQUIPMENT, SOLID MASONRY WALLS AND GATES EQUAL TO, OR GREATER THAN, THE HIGHEST POINT ON THE MECHANICAL EQUIPMENT SHALL SCREEN ALL GROUNE MOUNTED MECHANICAL EQUIPMENT.
- MOUNTED MECHANICAL EQUIPMENT.

 ANY ROOF ACCESS LADDERS SHALL BE LOCATED INSIDE THE BUILDING. ROOF DRAINAGE SHALL UTILL INTERIOR ROOF DRAINS OR BE ARCHITECTURINITED AND THE BUILDING DESIGN.

 ARCHITECTURALLY INTEGRATED FLOOR DRAINS SHAL REQUIRE ADDITIONAL ARTICULATION BEYOND PAINT ACCENTS. SECTION 35—1902 (8)(e)(15), ZONING CODE. SCREENING SHALL BE ARCHITECTURALLY INTEGRATE
- 5. SIGNS REQUIRE A SEPARATE SUBMITTAL AND PERMIT ALL ROOF EQUIPMENT, HVAC, TRASH CHUTE AND ANY ELEVATOR VENTS, ETC. ARE TO BE BELOW THE LOWEST BUILDING PARAPET ELEVATION.

EXTERIOR COLOR SCHEME 1:		
A LIGHT STUCCO COLOR	BENJAMIN MOOR 2123-70 ICE MIST	
B MIDRANGE STUCCO COLOR	DUNN EDWARDS DE6255 WISHING WELL	
C DARK STUCCO COLOR	DUNN EDWARDS DE6327 RHINOCEROS	
D RAILINGS/CANOPIES /DOORS/ACCENT	DUNN EDWARDS DEA187 BLACK	
E ROUGH TEXTURED FIBER CEMENT SIDING	DUNN EDWARDS DET681 MODERN CLASS	
F STONE VENEER	CORONADO SAWTOOTH LEDG WHITE	
G BRICK VENEER	SUMMIT FACE BRI 702 TBL CONCORDE	
H WINDOW/STOREFRONT /CARPORTS	WHITE	

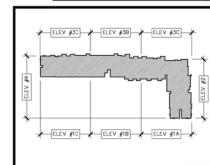

REZONE RESUBMITTAL 10/02/2020

2 4

A3.9C

BUILDING 1 - EXTERIOR ELEVATIONS



- EXTERIOR STUCCO SYSTEM
- STUCCO PARAPET CAP FULLY SCREENED MECHANICAL UNITS BEYOND
- LIGHT FIXTURE
- FOAM/STUCCO POP-OUT WITH SAND FINISH
- WINDOW
- METAL BALCONY RAILING DOOR PER PLAN
- 9. STUCCO CONTROL JOINT
- 10. GARAGE DOOR 1. METAL RAILING
- 12. ALUMNUM STOREFRONT WINDOW SYSTEM
- 13. FRAMED BALCONY
- 14. ALUMNUM TELESCOPING DOOR SYSTEM
- 15. STONE VENEER
- 16. LOW WALL
- 7. METAL GATE
- 18. FIBER CEMENT SIDING 19. METAL CANOPY, PAINTED
- 20. BRICK VENEER
- 21. METAL GATE/ENCLOSURE FOR FULLY SCREENED ELECTRICAL EQUIPMENT

GENERAL ELEVATION NOTES:



biltform architecture group, LLC.

11460 north cave creek road , suite 11 phoenix , arizona 8 5 0 2 0
Phone 602.285.9200 Fax 602.285.9229

PREIMINARY CONSTRUCTION

PARTNERS Suite 201, Scottsdale, AZ. 85258

WOOD F. Via De Ventura, S.

шi


ALL ROOF MOUNTED MECHANICAL EQUIPMENT SHALL BE FULLY SCREENED BY PARAPET WALLS EQUAL TO, OR GREATER THAN, THE HIGHEST POINT ON THE MECHANICAL EQUIPMENT.

- SOLIO MASONRY WALLS AND GATES EQUAL TO, OR GREATER THAN, THE HIGHEST POINT ON THE MECHANICAL EQUIPMENT SHALL SCREEN ALL GROUND MOUNTED MECHANICAL EQUIPMENT.
- MOUNTED MECHANICAL EQUIPMENT.

 ANY ROOF ACCESS LADDERS SHALL BE LOCATED INSIDE THE BUILDING. ROOF DRAINAGE SHALL UTILE INTERIOR ROOF DRAINS OR BE ARCHTECTURALLY INTEGRATED INTO THE BUILDING DESIGN.

 ARCHTECTURALLY INTEGRATED FLOOR DRAINS SHALL REQUIRE ADDITIONAL ARTICULATION BEYOND PAINT ACCENTS. SECTION 35—1902 (8)(e)(15), ZONING CODE. SCREENING SHALL BE ARCHITECTURALLY INTEGRATE
- SCREENING SHALL BE ARCHITECTURALLY INTEGRATE FOR THE SERVICE ENTENON SCS AND AUTILITIES. ALL GROUND MOUNTED EQUIPMENT SHAU UTILITIES. ALL GROUND MOUNTED EQUIPMENT SHAU BE SCREENED FROM PUBLIC WEW BY A CONCRETE C MASCARY WALL WITH SOULD GATES, EQUAL TO OR GREATER IN HEIGHT THAN THE WECHANICAL EQUIPMENT. SECTION 35–1902 (8)(e)13, ZONING CODE.
- SIGNS REQUIRE A SEPARATE SUBMITTAL AND PERMIT ALL ROOF EQUIPMENT, HVAC, TRASH CHUTE AND ANY ELEVATOR VENTS, ETC. ARE TO BE BELOW THE LOWEST BUILDING PARAPET ELEVATION.

EXTERIOR COLOR SCHEM	E 1;
A LIGHT STUCCO COLOR	BENJAMIN MOOR 2123-70 ICE MIST
B MIDRANGE STUCCO COLOR	DUNN EDWARDS DE6255 WISHING WELL
C DARK STUCCO COLOR	DUNN EDWARDS DE6327 RHINOCEROS
D RAILINGS/CANOPIES /DOORS/ACCENT	DUNN EDWARDS DEA187 BLACK
E ROUGH TEXTURED FIBER CEMENT SIDING	DUNN EDWARDS DET681 MODERN CLASS
F STONE VENEER	CORONADO SAWTOOTH LEDG WHITE
G BRICK VENEER	SUMMIT FACE BRI 702 TBL CONCORDE
H WINDOW/STOREFRONT /CARPORTS	WHITE

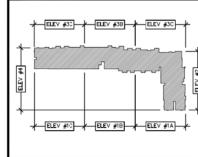

ш 王 ⋖ ORE **Ш** Б CHANDL ⋖ ₹

퐀

 $\overline{\mathsf{A}}$

Δ

REZONE RESUBMITTAL 10/02/2020

10/02/202	.0
REVISIONS:	
<u>^</u> -	
<u>^</u> -	
<u>3</u> -	
<u></u>	
<u>\$</u>	
JOB NO:	19-0
SCALE:	1/8" = 1
SHEET NO:	





ELEVATION KEY NOTES: # 1. EXTERIOR STUCCO SYSTEM 2. STUCCO PARAPET CAP Ε 3. FULLY SCREENED MECHANICAL UNITS BEYOND. t u 5. FOAM/STUCCO POP-OUT WITH SAND FINISH 0 C ᅩ 12. ALUMNUM STOREFRONT WINDOW SYSTEM 14. ALUMINUM TELESCOPING DOOR SYSTEM q biltform architecture 21. METAL GATE/ENCLOSURE FOR FULLY SCREENED ELECTRICAL EQUIPMENT group, LLC. 11460 north cave creek road . suite 11 phoenix . arizona 8 5 0 2 0 Phone 602 285 9200 Fax 602 285 9229 PREIMINARY CONSTRUCTION

폿

 $\overline{\forall}$

 \Box

ш

王

A AT Homes

E E

CHANDLE Apartine

 \triangleleft

. F

PARTNERS
Suite 201, Scottsdale, AZ. 85258

WOOD F

GENERAL ELEVATION NOTES:

ALL ROOF MOUNTED MECHANICAL EQUIPMENT SHALL BE FULLY SCREENED BY PARAPET WALLS EQUAL TO OR GREATER THAN, THE HIGHEST POINT ON THE MECHANICAL EQUIPMENT.

SOUID MASONRY WALLS AND GATES EQUAL TO, OR GREATER THAN, THE HIGHEST POINT ON THE MECHANICAL EQUIPMENT SHALL SCREEN ALL GROUNI MOUNTED MECHANICAL EQUIPMENT.

MOUNTED MECHANICAL EQUIPMENT.

ANY ROOF ACCESS LADDERS SHALL BE LOCATED INSIDE THE BUILDING. ROOF DRAINAGE SHALL UTIL NIERIGR ROOF DRAINS OR BE ARCHITECTURALLY INTEGRATED INTO THE BUILDING BESIGN. ARCHITECTURALLY INTEGRATED FLOOR DRAINS SHALL ROOM.


ARCHITECTURALLY INTEGRATED FLOOR DRAINS SHALL ROOM.

ACCINITIS. SECTION 35–1902 (8)(9)(15), ZONNG CODE.

. SIGNS REQUIRE A SEPARATE SUBMITTAL AND PERMIT ALL POOF EQUIPMENT, HVAC, TRASH CHUTE AND ANY ELEVATOR VENTS, ETC. ARE TO BE BELOW THE LOWEST BUILDING PARAPET ELEVATION.

EXTERIOR COLOR SCHEME 1

A LIGHT STUCCO COLOR	BENJAMIN MOOR 2123-70 ICE MIST
B MIDRANGE STUCCO COLOR	DUNN EDWARDS DE6255 WISHING WELL
C DARK STUCCO COLOR	DUNN EDWARDS DE6327 RHINOCEROS
D RAILINGS/CANOPIES /DOORS/ACCENT	DUNN EDWARDS DEA187 BLACK
E ROUGH TEXTURED FIBER CEMENT SIDING	DUNN EDWARDS DET681 MODERN CLASS
F STONE VENEER	CORONADO SAWTOOTH LEDG WHITE
G BRCK VENEER	SUMMIT FACE BRI 702 TBL CONCORDE
H WINDOW/STOREFRONT /CARPORTS	WHITE

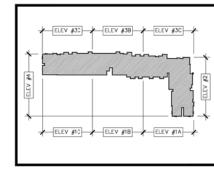

REZONE RESUBMITTAL 10/02/2020

2 4

A3.10C





- EXTERIOR STUCCO SYSTEM
- STUCCO PARAPET CAP
- FULLY SCREENED MECHANICAL UNITS BEYOND
- LIGHT FIXTURE
- FOAM/STUCCO POP-OUT WITH SAND FINISH WINDOW
- METAL BALCONY RAILING DOOR PER PLAN
- 9. STUCCO CONTROL JOINT
- 10. GARAGE DOOR
- 1. METAL RAILING 12. ALUMNUM STOREFRONT WINDOW SYSTEM
- 13. FRAMED BALCONY
- 4. ALUMNUM TELESCOPING DOOR SYSTEM
- 15. STONE VENEER 16. LOW WALL
- 7. METAL GATE
- 18. FIBER CEMENT SIDING
- 19. METAL CANOPY, PAINTED 20. BRICK VENEER
- METAL GATE/ENCLOSURE FOR FULLY SCREENED ELECTRICAL EQUIPMENT

Е t u 0 C p

biltform architecture group, LLC.

11460 north cave creek road , suite 11 phoenix , arizona 8 5 0 2 0
Phone 602.285.9200 Fax 602.285.9229

PREIMINARY CONSTRUCTION

PARTNERS
Suite 201, Scottsdale, AZ. 85258

WOOD F


GENERAL ELEVATION NOTES:

- ALL ROOF MOUNTED MECHANICAL EQUIPMENT SHALL BE FULLY SCREENED BY PARAPET WALLS EQUAL TO OR GREATER THAN, THE HIGHEST POINT ON THE MECHANICAL EQUIPMENT.
- SOLID MASONRY WALLS AND GATES EQUAL TO, OR GREATER THAN, THE HIGHEST POINT ON THE MECHANICAL EQUIPMENT SHALL SCREEN ALL GROUNI MOUNTED MECHANICAL EQUIPMENT.
- MOURIED MECHANICAL EQUIPMENT.

 ANY BOOF ACCESS LADDERS SHALL BE LOCATED INSIDE THE BUILDING ROOF DRAINAGE SHALL UTLI. INTERIOR ROOF DRAINS OF BE ARCHTECTURALLY INTERIOR ROOF DRAINS OF BE ARCHTECTURALLY INTERIOR BOSIGN.

 ARCHITECTURALLY INTERRATED FLOOR DRAINS SHALL REQUIRE ADDITIONAL ARTICULATION BEYOND PAINT ACCENTS. SECTION 35–1902 (8)(e)(15), ZONING CODE.
- SCHEDNING SHALL BE ARCHITECTURALLY INTEGRATED FOR THE SERVICE ENTRANCE SECTION (SES) AND ALL UITLIES. ALL GROWND MOUNTED EQUIPMENT SHALL BE SCREENED FROM PUBLIC WEW BY A CONCRETE OF MASCINRY WALL WITH SOLID GATE, EQUAL TO OR GRAZIER IN HEIGHT THAN THE MECHANICAL EQUIPMENT. SECTION 35–1902 (8)(e)13, ZONING COOE.
- SIGNS REQUIRE A SEPARATE SUBMITTAL AND PERMIT ALL ROOF EQUIPMENT, HVAC, TRASH CHUTE AND ANY ELEVATOR VENTS, ETC. ARE TO BE BELOW THE LOWEST BUILDING PARAPET ELEVATION.

EXTERIOR COLOR SCHEM	E 1;
A LICHT STUCCO COLOR	BENJAMIN MOORE 2123-70 ICE MIST
B MIDRANGE STUCCO COLOR	DUNN EDWARDS DE6255 WISHING WELL
C DARK STUCCO COLOR	DUNN EDWARDS DE6327 RHINOCEROS
D RAILINGS/CANOPIES / DOORS/ACCENT	DUNN EDWARDS DEA187 BLACK
E ROUGH TEXTURED FIBER CEMENT SIDING	DUNN EDWARDS DET681 MODERN CLASS
F STONE VENEER	CORONADO SAWTOOTH LEDGE WHITE
G BRICK VENEER	SUMMIT FACE BRIC 702 TBL CONCORDE
H WINDOW/STOREFRONT	WHITE

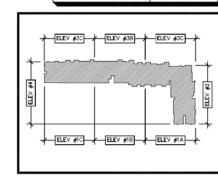

Ш Бृ≝ CHANDL ⋖ F

폿

 $\overline{\forall}$ ₽

ш

폰

⋖

REZONE RESUBMITTAL 10/02/2020

REVISIONS:	
<u> </u>	
<u>^</u> -	
<u>\$</u> -	
<u></u>	
<u>\$</u>	
JOB NO:	19-0
SCALE:	1/8" = 1
CLIEFT NO.	



EAST ELEVATION
BUILDING #2





ELEVATION KEY NOTES: (#)

- 1. EXTERIOR STUCCO SYSTEM
- 2. STUCCO PARAPET CAP
- 3. FULLY SCREENED MECHANICAL UNITS BEYOND.
- 4. LIGHT FIXTURE
- 5. FOAM/STUCCO POP-OUT WITH SAND FINISH
- 6. WINDOW
- 7. METAL BALCONY RAILING 8. DOOR PER PLAN
- 9. STUCCO CONTROL JOINT
- 10. GARAGE DOOR
- 11. METAL RAILING
- 12. ALUMINUM STOREFRONT WINDOW SYSTEM 13. FRAMED BALCONY
- 14. ALUMINUM TELESCOPING DOOR SYSTEM
- 15. STONE VENEER 16. LOW WALL
- 17. METAL GATE
- 18. FIBER CEMENT SIDING
- 19. METAL CANOPY, PAINTED 20. BRICK VENEER
- 21. METAL GATE/ENCLOSURE FOR FULLY SCREENED ELECTRICAL EQUIPMENT

GENERAL ELEVATION NOTES:

Е - \supset 0 C q

biltform architecture group, LLC.

11460 north cave creek road . suite 11 phoenix . arizona 85020 Phone 602,285,9200 Fax 602,285,9229

PRELIMINARY CONSTRUCTION

PARTNERS
Suite 201, Scottsdale, AZ. 85258

WOOD F

폿

 $\overline{\forall}$

 \Box


ш

王

ALL ROOF MOUNTED MECHANICAL EQUIPMENT SHALL BE FULLY SCREENED BY PARAPET WALLS EQUAL TO OR GREATER THAN, THE HIGHEST POINT ON THE MECHANICAL EQUIPMENT.

- MCCIPANICAL EQUIPMENT, SOLID MASONRY WALLS AND GATES EQUAL TO, OR GREATER THAN, THE HIGHEST POINT ON THE MECHANICAL EQUIPMENT SHALL SCREEN ALL GROUNE MOUNTED MECHANICAL EQUIPMENT.
- MOUNTED MECHANICAL EQUIPMENT.
 ANY ROOF ACCESS LADDERS SHALL BE LOCATED
 INSDETHE BUILDING. ROOF DRAINAGE SHALL UTIL
 INTEROR ROOF BRAINS ON BE ARCHITECTURALLY
 INTEROR ROOF BRAINS ON BE ARCHITECTURALLY
 ARCHITECTURALLY INTERDATED FLOOR BRAINS SHAL
 REQUIRE ADDITIONAL ARTICULATION BEYOND PAINT
 ACCENTS. SECTION 35–1902 (8)(e)(15), ZONING
 CODE.
- . SIGNS REQUIRE A SEPARATE SUBMITTAL AND PERMIT ALL ROOF EQUIPMENT, HVAC, TRASH CHUTE AND ANY ELEVATOR VENTS, ETC. ARE TO BE BELOW THE LOWEST BUILDING PARAPET ELEVATION.

EXTERIOR COLOR SCHEME 1:	
A LIGHT STUCCO COLOR	BENJAMIN MOOR 2123-70 ICE MIST
B MIDRANGE STUCCO COLOR	DUNN EDWARDS DE6255 WISHING WELL
C DARK STUCCO COLOR	DUNN EDWARDS DE6327 RHINOCEROS
D RAILINGS/CANOPIES /DOORS/ACCENT	DUNN EDWARDS DEA187 BLACK
E ROUGH TEXTURED FIBER CEMENT SIDING	DUNN EDWARDS DET681 MODERN CLASS
F STONE VENEER	CORONADO SAWTOOTH LEDO WHITE
G BRICK VENEER	SUMMIT FACE BR 702 TBL CONCORDE
H WINDOW/STOREFRONT /CARPORTS	WHITE

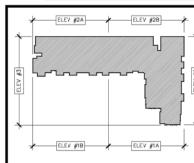

A AT **Ш** ॄ CHANDLE Apartine \triangleleft F

REZONE RESUBMITTAL 10/02/2020

REVI	ISIONS:	
Λ	-	
2	-	
3	-	
4	-	
<u>/5\</u>		
JOBA	Mr.	19.0

A4.4C



- EXTERIOR STUCCO SYSTEM
- STUCCO PARAPET CAP
- FULLY SCREENED MECHANICAL UNITS BEYOND
- LIGHT FIXTURE
- FOAM/STUCCO POP-OUT WITH SAND FINISH
- WINDOW
- METAL BALCONY RAILING DOOR PER PLAN
- 9. STUCCO CONTROL JOINT
- 10. GARAGE DOOR
- 1. METAL RAILING 12. ALUMNUM STOREFRONT WINDOW SYSTEM
- 13. FRAMED BALCONY
- 14. ALUMINUM TELESCOPING DOOR SYSTEM
- 15. STONE VENEER 16. LOW WALL
- 7. METAL GATE
- 18. FIBER CEMENT SIDING
- 19. METAL CANOPY, PAINTED
- 20. BRICK VENEER 21. METAL GATE/ENCLOSURE FOR FULLY SCREENED ELECTRICAL EQUIPMENT

ם 0 p

Е

biltform architecture group, LLC.

11460 north cave creek road , suite 11 phoenix , arizona 8 5 0 2 0
Phone 602.285.9200 Fax 602.285.9229

PRELIMINARY CONSTRUCTION

PARTNERS
Suite 201, Scottsdale, AZ. 85258

WOOD F

퐀

 $\overline{\forall}$

₽

ш

폰


GENERAL ELEVATION NOTES:

- ALL ROOF MOUNTED MECHANICAL EQUIPMENT SHALL BE FULLY SCREENED BY PARAPET WALLS EQUAL TO OR GREATER THAN, THE HIGHEST POINT ON THE MECHANICAL EQUIPMENT.
- SOLID MASONRY WALLS AND GATES EQUAL TO, OR GREATER THAN, THE HIGHEST POINT ON THE MECHANICAL EQUIPMENT SHALL SCREEN ALL GROUNI MOUNTED MECHANICAL EQUIPMENT.
- MOUNTED MECHANICAL EQUIPMENT.

 ANY ROOF ACCESS LADDERS SHALL BE LOCATED
 INSIDE THE BUILDING. ROOF DRAINAGE SHALL UTIL
 INTERIOR ROOF DRAINS OR BE ARCHTECTURALLY
 INTEGRATED INTO THE BUILDING DESIGN.
 ARCHTECTURALLY INTEGRATED FLOOR DRAINS SHALL
 REQUIRE ADDITIONAL ARTICULATION BEYOND PAINT
 ACCENTS. SECTION 35—1902 (8)(e)(15), ZONING
 CODE.
- SCREENING SHALL BE ARCHITECTURALLY INTEGRATE SCREENING SHALL BE ARCHITECTURALLY INTEGRATE FOR THE SERVICE EXCITON (SSS) AND AL UTILITIES. ALL GROUND MOUNTED EQUIPMENT SHALL BE SCREENED FROM PUBLIC WEW BY A CONCRETE C MASCARY WALL WITH SOULD GATES, EQUAL TO OR GREATER IN HEIGHT THAN THE WECHANICAL EQUIPMENT. SECTION 35–1902 (8)(e)13, ZONING CODE.
- SIGNS REQUIRE A SEPARATE SUBMITTAL AND PERMIT ALL ROOF EQUIPMENT, HVAC, TRASH CHUTE AND ANY ELEVATOR VENTS, ETC. ARE TO BE BELOW THE LOWEST BUILDING PARAPET ELEVATION.

EXTERIOR COLOR SCHEME 1:

EXTERIOR COLOR SCHEME 1;		
A LICHT STUCCO COLOR	BENJAMIN MO 2123-70 ICE MIST	
B MIDRANGE STUCCO COLOR	DUNN EDWA DE6255 WISHING WE	
C DARK STUCCO COLOR	DUNN EDWA DE6327 RHINOCERC	
D RAILINGS/CANOPIES / DOORS/ACCENT	DUNN EDWA DEA187 BLACK	
E ROUGH TEXTURED FIBER CEMENT SIDING	DUNN EDWA DET681 MODERN CL	
F STONE VENEER	CORONAD SAWTOOTH LI WHITE	
G BRICK VENEER	SUMMIT FACE 702 TBL CONCORD	
H WINDOW/STOREFRONT /CARPORTS	WHITE	

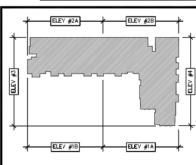

A AT OORE ARDS Ш CHANDL LASS DO LEDGE BRICK ∢ ₹

REZONE RESUBMITTAL 10/02/2020

REVISIONS:	
<u>^</u> -	
<u>∕</u> 2 -	
<u>3</u> -	
<u>A</u> -	
<u>\$</u>	
JOB NO:	19-0
SCALE:	1/8" = 1

A4.4







- 1. EXTERIOR STUCCO SYSTEM
- 2. STUCCO PARAPET CAP
- 3. FULLY SCREENED MECHANICAL UNITS BEYOND.
- 4. LIGHT FIXTURE
- 5. FOAM/STUCCO POP-OUT WITH SAND FINISH
- 6. WINDOW 7. METAL BALCONY RAILING
- 8. DOOR PER PLAN 9. STUCCO CONTROL JOINT
- 10. GARAGE DOOR 11. METAL RAILING
- 12. ALUMINUM STOREFRONT WINDOW SYSTEM
- 13. FRAMED BALCONY
- 14. ALUMINUM TELESCOPING DOOR SYSTEM
- 15. STONE VENEER
- 16. LOW WALL
- 17. METAL GATE 18. FIBER CEMENT SIDING
- 19. METAL CANOPY, PAINTED
- 20. BRICK VENEER 21. METAL GATE/ENCLOSURE FOR FULLY SCREENED ELECTRICAL EQUIPMENT

GENERAL ELEVATION NOTES:



biltform architecture group, LLC.

11460 north cave creek road . suite 11 phoenix . arizona 85020 Phone 602,285,9200 Fax 602,285,9229

PREIMINARY CONSTRUCTION

PARTNERS
Suite 201, Scottsdale, AZ. 85258

WOOD F. Via De Ventura, S.

ш

폿

 $\overline{\forall}$

 \Box ш

王

A AT Homes

<u>Ш</u> ё́ ё́

CHANDLE Apartme

 \triangleleft

F

 α

ALL ROOF MOUNTED MECHANICAL EQUIPMENT SHALL BE FULLY SCREENED BY PARAPET WALLS EQUAL TO OR GREATER THAN, THE HIGHEST POINT ON THE MECHANICAL EQUIPMENT. MCCPANICAL EQUIPMENT, SOLID MASONRY WALLS AND GATES EQUAL TO, OR GREATER THAN, THE HIGHEST POINT ON THE MECHANICAL EQUIPMENT SHALL SCREEN ALL GROUND MOUNTED MECHANICAL EQUIPMENT.

- MOUNTED MECHANICAL EQUIPMENT.

 ANY ROOF ACCESS LADDERS SHALL BE LOCATED INSIDE THE BUILDING. ROOF DRAINAGE SHALL UTIL, INTERIOR ROOF DRAINS OR BE ARCHTECTURALLY INTERIOR ACCOUNTED THE BUILDING DESIGN.


 ARCHTECTURALLY INTERRATED FLOOR DRAINS SHALL REQUIRE ADDITIONAL ARTICULATION BEYOND PAINT ACCENTS. SECTION 35—1902 (8)(e)(15), ZONING CODE.
- COUL.

 SCREENING SHALL BE ARCHITECTURALLY INTEGRATED FOR THE SERVICE ENTRANCE SECTION (SES) AND ALL UTILITIES. ALL GROUND MOUNTED EQUIPMENT SHALL BE SPREEMED FROM PUBLIC VIEW BY A CONCRETE OMASKINEY WALL WITH SOULD CATES, EQUAL TO OR GREATER IN HEIGHT THAN THE MECHANICAL CONCRETE SECTION 35–1902 (8)(e)13, ZONING COOL.
- . SIGNS REQUIRE A SEPARATE SUBMITTAL AND PERMIT ALL ROOF EQUIPMENT, HVAC, TRASH CHUTE AND ANY ELEVATOR VENTS, ETC. ARE TO BE BELOW THE LOWEST BUILDING PARAPET FLEVATION

EXTERIOR COLOR SCHEME 1 BENJAMIN MOORE 2123-70 A LIGHT STUCCO COLOR

_	ICE MIST
B MIDRANGE STUCCO COLOR	DUNN EDWARD DE6255 WISHING WELL
C DARK STUCCO COLOR	DUNN EDWARD DE6327 RHINOCEROS
D RAILINGS/CANOPIES /DOORS/ACCENT	DUNN EDWARD DEA187 BLACK
E ROUGH TEXTURED FIBER CEMENT SIDING	DUNN EDWARD DE T681 MODERN CLAS
F STONE VENEER	CORONADO SAWTOOTH LED WHITE


G BRCK VENEER H WNDOW/STOREFRONT /CARPORTS

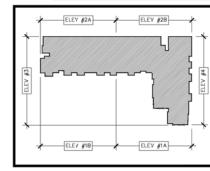

REZONE RESUBMITTAL 10/02/2020

REV	ISIONS:	
Λ	-	
2	-	
3	-	
4	-	
<u>/</u> 5\		
JOB1	NO:	19-0

A4.5C

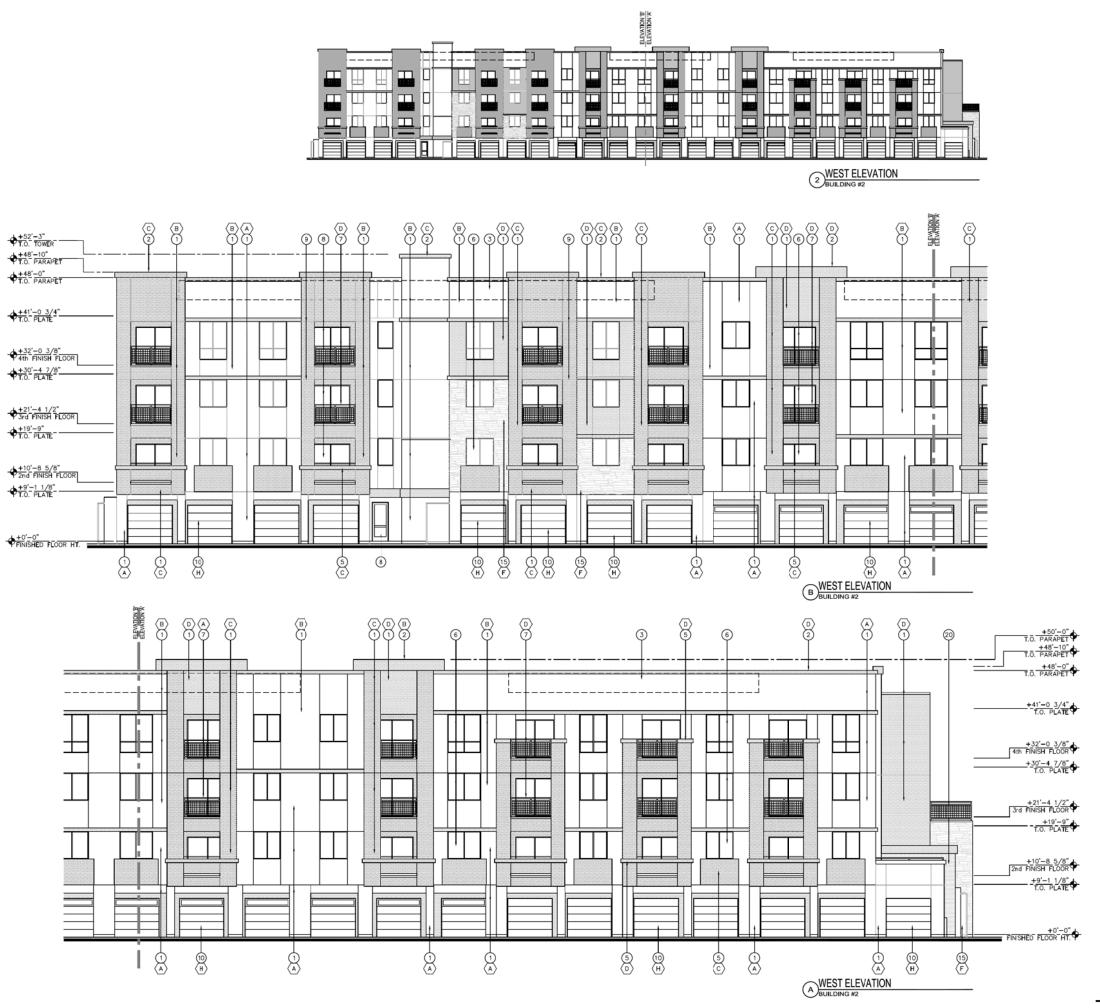

- EXTERIOR STUCCO SYSTEM
- STUCCO PARAPET CAP
- FULLY SCREENED MECHANICAL UNITS BEYOND
- LIGHT FIXTURE
- FOAM/STUCCO POP-OUT WITH SAND FINISH
- WINDOW METAL BALCONY RAILING
- DOOR PER PLAN 9. STUCCO CONTROL JOINT
- 10. GARAGE DOOR
- 1. METAL RAILING
- 12. ALUMNUM STOREFRONT WINDOW SYSTEM 13. FRAMED BALCONY
- 14. ALUMNUM TELESCOPING DOOR SYSTEM
- 15. STONE VENEER
- 16. LOW WALL 7. METAL GATE
- 18. FIBER CEMENT SIDING
- 19. METAL CANOPY, PAINTED
- 20. BRICK VENEER 21. METAL GATE/ENCLOSURE FOR FULLY SCREENED ELECTRICAL EQUIPMENT

GENERAL ELEVATION NOTES:

Е -ם 0 C p

biltform architecture group, LLC.

11460 north cave creek road , suite 11 phoenix , arizona 8 5 0 2 0
Phone 602.285.9200 Fax 602.285.9229

PRELIMINARY CONSTRUCTION

PARTNERS
Suite 201, Scottsdale, AZ. 85258

WOOD F

퐀

 $\overline{\forall}$

₽

ш

폰

ALL ROOF MOUNTED MECHANICAL EQUIPMENT SHALL BE FULLY SCREENED BY PARAPET WALLS EQUAL TO, OR GREATER THAN, THE HIGHEST POINT ON THE MECHANICAL EQUIPMENT. SOLID MASONRY WALLS AND GATES EQUAL TO, OR GREATER THAN, THE HIGHEST POINT ON THE MECHANICAL EQUIPMENT SHALL SCREEN ALL GROUNI MOUNTED MECHANICAL EQUIPMENT.

MOUNTED MECHANICAL EQUIPMENT.


ANY ROOF ACCESS LADDERS SHALL BE LOCATED INSIDE THE BUILDING. ROOF DRAINAGE SHALL UTILS INTERIOR ROOF DRAINS OR BE ARCHTECTURALLY INTEGRATED INTO THE BUILDING DESIGN.

ARCHTECTURALLY INTEGRATED FLOOR DRAINS SHALL REQUIRE ADDITIONAL ARTICULATION BEYOND PAINT ACCENTS. SECTION 35–1902 (8)(e)(15), ZONING CODE.

- SCREENING SHALL BE ARCHITECTURALLY INTEGRATED SCREENING SHALL BE ARCHITECTURALLY INTEGRATE FOR THE SERVICE EXCITON (SSS) AND AL UTILITIES. ALL GROUND MOUNTED EQUIPMENT SHALL BE SCREENED FROM PUBLIC WEW BY A CONCRETE C MASCARY WALL WITH SOULD GATES, EQUAL TO OR GREATER IN HEIGHT THAN THE WECHANICAL EQUIPMENT. SECTION 35–1902 (8)(e)13, ZONING CODE.
- SIGNS REQUIRE A SEPARATE SUBMITTAL AND PERMIT ALL ROOF EQUIPMENT, HVAC, TRASH CHUTE AND ANY ELEVATOR VENTS, ETC. ARE TO BE BELOW THE LOWEST BUILDING PARAPET ELEVATION.

EXTERIOR COLOR SCHEME	1:
EXTENSIVE COLOR CONTENIE	٠.

EXTENSOR COLOR SCHEME 1.		
A LICHT STUCCO COLOR	BENJAMIN MOORE 2123-70 ICE MIST	
B MIDRANGE STUCCO COLOR	DUNN EDWARDS DE6255 WISHING WELL	
C DARK STUCCO COLOR	DUNN EDWARDS DE6327 RHINOCEROS	
D RAILINGS/CANOPIES /DOORS/ACCENT	DUNN EDWARDS DEA187 BLACK	
E ROUGH TEXTURED FIBER CEMENT SIDING	DUNN EDWARDS DET681 MODERN CLASS	
F STONE VENEER	CORONADO SAWTOOTH LEDGE WHITE	
G BRICK VENEER	SUMMIT FACE BRICK 702 TBL CONCORDE	
H WINDOW/STOREFRONT /CARPORTS	WHITE	

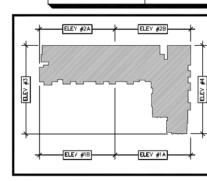

⋖ **Ш** हिं CHANDL ₹

REZONE RESUBMITTAL 10/02/2020

REVISIONS:	
<u> </u>	
<u>∕</u> 2 -	
<u>3</u> -	
<u>A</u> -	
<u>\$</u>	
JOB NO:	19-0
SCALE:	1/8" = 1
SHEET NO:	

A4.5





- 1. EXTERIOR STUCCO SYSTEM
- 2. STUCCO PARAPET CAP
- 3. FULLY SCREENED MECHANICAL UNITS BEYOND.
- 4. LIGHT FIXTURE
- 5. FOAM/STUCCO POP-OUT WITH SAND FINISH
- 6. WINDOW
- 7. METAL BALCONY RAILING
- 8. DOOR PER PLAN
- 9. STUCCO CONTROL JOINT 10. GARAGE DOOR
- 11. METAL RAILING
- 12. ALUMINUM STOREFRONT WINDOW SYSTEM 13. FRAMED BALCONY
- 14. ALUMINUM TELESCOPING DOOR SYSTEM
- 15. STONE VENEER
- 16. LOW WALL 17. METAL GATE
- 18. FIBER CEMENT SIDING
- 19. METAL CANOPY, PAINTED
- 20. BRICK VENEER 21. METAL GATE/ENCLOSURE FOR FULLY SCREENED ELECTRICAL EQUIPMENT



biltform architecture group, LLC.

11460 north cave creek road . suite 11 phoenix . arizona 8 50 2 0 Phone 602 285 9200 Fax 602 285 9229

PARTNERS
Suite 201, Scottsdale, AZ. 85258

WOOD F

PRELIMINARY CONSTRUCTION GENERAL ELEVATION NOTES:

폿

 $\overline{\forall}$

 \Box


ш

工

- ALL ROOF MOUNTED MECHANICAL EQUIPMENT SHALL BE FULLY SCREENED BY PARAPET WALLS EQUAL TO OR GREATER THAN, THE HIGHEST POINT ON THE MECHANICAL EQUIPMENT.
- MCCIPANICAL EQUIPMENT, SOLID MASONRY WALLS AND GATES EQUAL TO, OR GREATER THAN, THE HIGHEST POINT ON THE MECHANICAL EQUIPMENT SHALL SCREEN ALL GROUNE MOUNTED MECHANICAL EQUIPMENT.
- MOUNTED MECHANICAL EQUIPMENT.
 ANY ROOF ACCESS LADDERS SHALL BE LOCATED INSD: THE BUILDING. ROOF DRAINAGE SHALL UTILL INTEROR ROOF BRAINS OR BE ARCHITECTURALLY INTEROR ROOF BRAINS OR BE ARCHITECTURALLY CONTROL TO THE ROOF BRAINS SHALL REQUIRE ADDITIONAL ARTICUJATION BEYOND PAINT ACCENTS. SECTION 35–1902 (8)(e)(15), ZONING CODE.
- SCREENING SHALL BE ARCHITECTURALLY INTEGRATE FOR THE SERVICE ENTRANCE SECTION (SES) AND A UTILITIES. ALL GROUND MOUNTED EQUIPMENT SHALD BE SCREENED FROM PUBBLIC VEW BY A CONCRETE MASCARY WALL WITH SOLID GATES, EQUAL TO OR GREATER IN HEIGHT THAN THE MECHANICAL EQUIPMENT. SECTION 35–1902 (8)(e)13, ZONING CODE.
- . SIGNS REQUIRE A SEPARATE SUBMITTAL AND PERMIT ALL ROOF EQUIPMENT, HVAC, TRASH CHUTE AND ANY ELEVATOR VENTS, ETC. ARE TO BE BELOW THE LOWEST BUILDING PARAPET ELEVATION.

EXTERIOR COLOR SCHEME 1

EXTERIOR GOEOR SCHEME 1.		
A LIGHT STUCCO COLOR	BENJAMIN MOOR 2123-70 ICE MIST	
B MIDRANGE STUCCO COLOR	DUNN EDWARDS DE6255 WISHING WELL	
C DARK STUCCO COLOR	DUNN EDWARDS DE6327 RHINOCEROS	
D RAILINGS/CANOPIES /DOORS/ACCENT	DUNN EDWARDS DEA187 BLACK	
E ROUGH TEXTURED FIBER CEMENT SIDING	DUNN EDWARDS DET681 MODERN CLASS	
F STONE VENEER	CORONADO SAWTOOTH LEDG WHITE	
G BRCK VENEER	SUMMIT FACE BRI 702 TBL CONCORDE	
H WINDOW/STOREFRONT	WHITE	

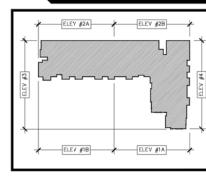

A AT Homes **Ш** ॄ CHANDLE Apartine ⋖ F

REZONE RESUBMITTAL 10/02/2020

10/02/2020	
REVISIONS:	
2 -	
<u>3</u> -	
4 -	
<u>\$</u>	
JOB NO:	19

A4.6C





- 1. EXTERIOR STUCCO SYSTEM
- 2. STUCCO PARAPET CAP
- 3. FULLY SCREENED MECHANICAL UNITS BEYOND.
- 4. LIGHT FIXTURE
- 5. FOAM/STUCCO POP-OUT WITH SAND FINISH
- 6. WINDOW 7. METAL BALCONY RAILING
- 8. DOOR PER PLAN
- 9. STUCCO CONTROL JOINT 10. GARAGE DOOR
- 11. METAL RAILING
- 12. ALUMINUM STOREFRONT WINDOW SYSTEM 13. FRAMED BALCONY
- 14. ALUMINUM TELESCOPING DOOR SYSTEM
- 15. STONE VENEER 16. LOW WALL
- 17. METAL GATE
- 18. FIBER CEMENT SIDING 19. METAL CANOPY, PAINTED
- 20. BRICK VENEER 21. METAL GATE/ENCLOSURE FOR FULLY SCREENED ELECTRICAL EQUIPMENT



PRELIMINARY CONSTRUCTION

PARTNERS
Suite 201, Scottsdale, AZ. 85258

WOOD F

q

Ε

0 C

-


t u

GENERAL ELEVATION NOTES:

- ALL ROOF MOUNTED MECHANICAL EQUIPMENT SHALL BE FULLY SCREENED BY PARAPET WALLS EQUAL TO OR GREATER THAN, THE HIGHEST POINT ON THE MECHANICAL EQUIPMENT.
- MCCIPANICAL EQUIPMENT, SOLID MASONRY WALLS AND GATES EQUAL TO, OR GREATER THAN, THE HIGHEST POINT ON THE MECHANICAL EQUIPMENT SHALL SCREEN ALL GROUNE MOUNTED MECHANICAL EQUIPMENT.
- MUNICID MECHANICAL EQUIPMENT.
 ANY ROOF ACCESS LADDERS SHALL BE LOCATED INSD: THE BUILDING. ROOF DRAINAGE SHALL UTILL INTEROR ROOF BRAINS ON BE ARCHITECTURALLY MERCHANGE SHALL UTILL ARCHITECTURALLY INTERDATED FLOOR BRAINS SHALL REQUIRE ADDITIONAL ARTICULATION BEYOND PAINT ACCENTS. SECTION 35–1902 (8)(e)(15), ZONING CODE.
- SCREENING SHALL BE ARCHITECTURALLY INTEGRATE FOR THE SERVICE ENTRANCE SECTION (SES) AND A UTILITIES. ALL GROUND MOUNTED EQUIPMENT SHALD BE SCREENED FROM PUBBLIC VEW BY A CONCRETE MASCARY WALL WITH SOLID GATES, EQUAL TO OR GREATER IN HEIGHT THAN THE MECHANICAL EQUIPMENT. SECTION 35–1902 (8)(e)13, ZONING CODE.
- . SIGNS REQUIRE A SEPARATE SUBMITTAL AND PERMIT ALL ROOF EQUIPMENT, HVAC, TRASH CHUTE AND ANY ELEVATOR VENTS, ETC. ARE TO BE BELOW THE LOWEST BUILDING PARAPET ELEVATION.

EXTERIOR COLOR SCHEME 1

EXTERIOR GOEOR SCHEME 1.	
A LIGHT STUCCO COLOR	BENJAMIN MOORE 2123-70 ICE MIST
B MIDRANGE STUCCO COLOR	DUNN EDWARDS DE6255 WISHING WELL
C DARK STUCCO COLOR	DUNN EDWARDS DE6327 RHINOCEROS
D RAILINGS/CANOPIES /DOORS/ACCENT	DUNN EDWARDS DEA187 BLACK
E ROUGH TEXTURED FIBER CEMENT SIDING	DUNN EDWARDS DET681 MODERN CLASS
F STONE VENEER	CORONADO SAWTOOTH LEDGE WHITE
G BRICK VENEER	SUMMIT FACE BRIG 702 TBL CONCORDE
H WNDOW/STOREFRONT	WHITE

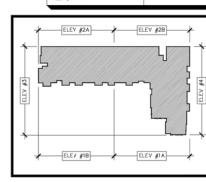

\Box ш 工 A AT Homes Ш e CHANDLE ⋖ F

폿

 $\overline{\forall}$

REZONE RESUBMITTAL 10/02/2020

REVI	SIONS:
Λ	-
<u>/2\</u>	-
<u> 3</u>	-
4	-
/s\	

A4.6C



Е \supset 0 q

biltform architecture group, LLC.

11460 north cave creek road . suite 11 phoenix . arizona 8 50 2 0 Phone 602 285 9200 Fax 602 285 9229

PARTNERS
Suite 201, Scottsdale, AZ. 85258


WOOD F. Via De Ventura, S

 \triangleleft

REZONE RESUBMITTAL 10/02/2020

REVISIONS:	
<u>^</u> -	
<u> </u>	
<u>3</u> -	
<u>\$</u>	
JOB NO:	13

A5.4C

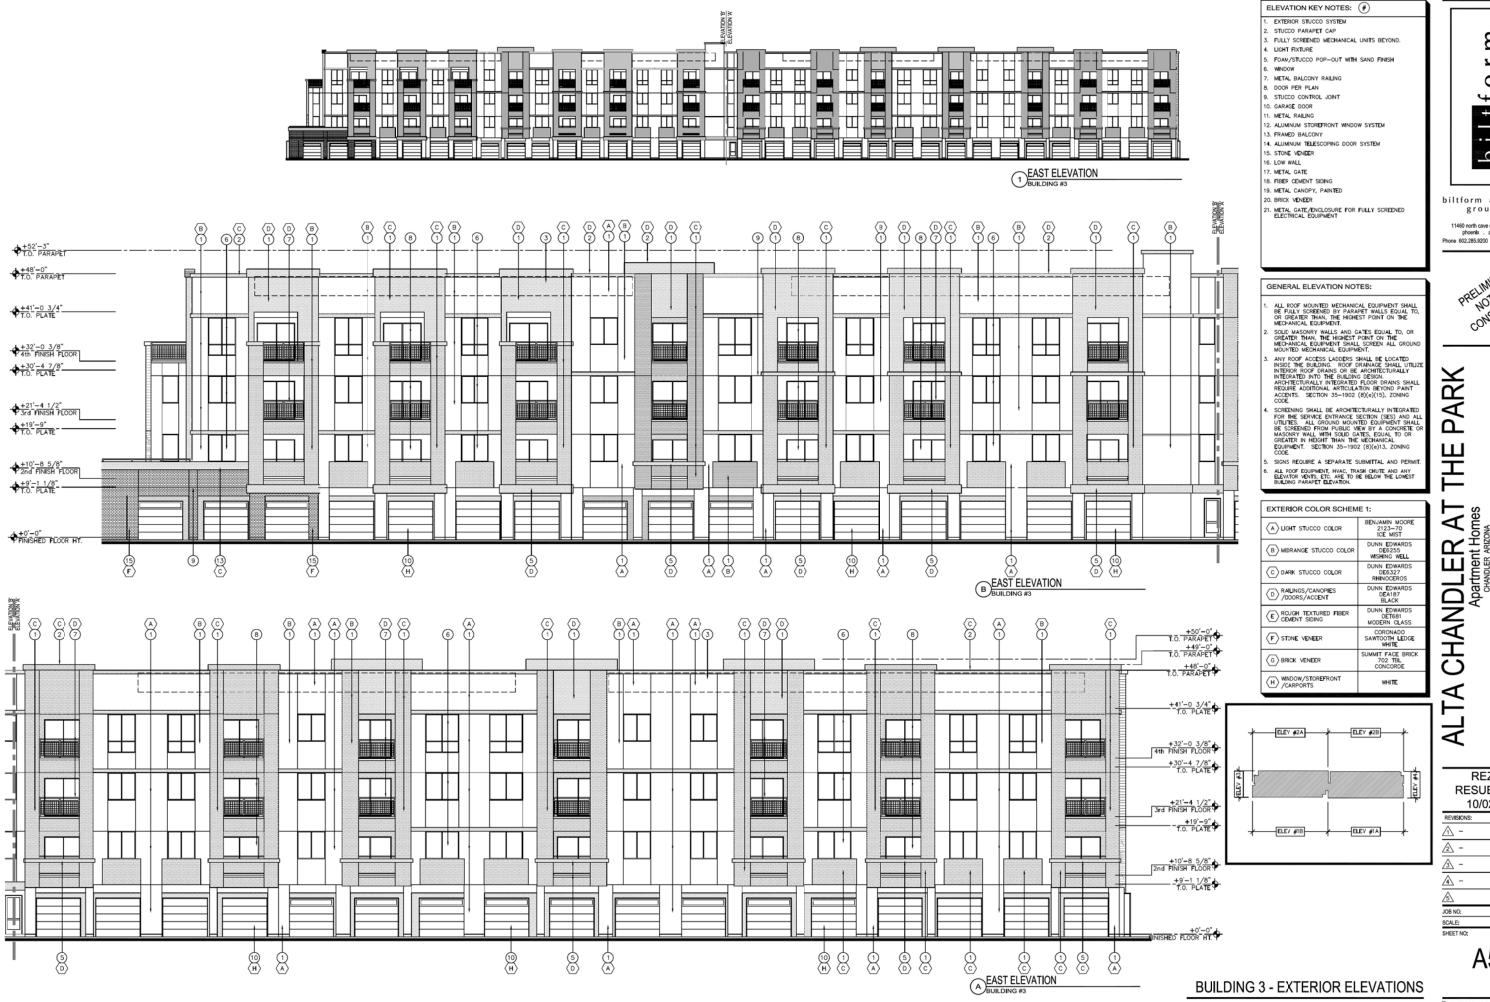

Ε -ם 0 p

biltform architecture group, LLC.

11460 north cave creek road , suite 11 phoenix , arizona 8 5 0 2 0 Phone 602.285.9200 Fax 602.285.9229

PREIMINARY CONSTRUCTION

PARTNERS
Suite 201, Scottsdale, AZ. 85258

WOOD F. Via De Ventura, S.

REZONE RESUBMITTAL 10/02/2020

REVISIONS: <u></u> -Ճ JOB NO:

A5.4



8

19

50

8

50

8

8

8

(D) H 50

WEST ELEVATION
BUILDING #3

ELEVATION KEY NOTES: (#)

1. EXTERIOR STUCCO SYSTEM

2. STUCCO PARAPET CAP

3. FULLY SCREENED MECHANICAL UNITS BEYOND.

4. LIGHT FIXTURE

5. FOAM/STUCCO POP-OUT WITH SAND FINISH 6. WINDOW

7. METAL BALCONY RAILING 8. DOOR PER PLAN

9. STUCCO CONTROL JOINT 10. GARAGE DOOR

11. METAL RAILING

12. ALUMINUM STOREFRONT WINDOW SYSTEM
13. FRAMED BALCONY

14. ALUMINUM TELESCOPING DOOR SYSTEM

15. STONE VENEER 16. LOW WALL

17. METAL GATE

18. FIBER CEMENT SIDING 19. METAL CANOPY, PAINTED

20. BRICK VENEER

21. METAL GATE/ENCLOSURE FOR FULLY SCREENED ELECTRICAL EQUIPMENT

biltform architecture

biltform architecture group, LLC.

11460 north cave creek road . suite 11 phoenix . arizona 85020 Phone 602,285,9200 Fax 602,285,9229

PREIMINARY CONSTRUCTION

PARTNERS
Suite 201, Scottsdale, AZ. 85258

WOOD F. Via De Ventura, S.

폿

 $\overline{\forall}$

Ш Д

王

GENERAL ELEVATION NOTES:

. ALL ROOF MOUNTED MECHANICAL EQUIPMENT SHALL BE FULLY SCREENED BY PARAPET WALLS EQUAL TO OR GREATER THAN, THE HIGHEST POINT ON THE MECHANICAL EQUIPMENT.

MCCI-PANICAL EQUIFMENT.

SOLID MASONRY WALLS AND GATES EQUAL TO, OR GREATER THAN, THE HIGHEST POINT ON THE MECHANICAL EQUIPMENT SHALL SCREEN ALL GROUND MOUNTED MECHANICAL EQUIPMENT.

MOUNTED MECHANICAL EQUIPMENT.
ANY ROOF ACCESS LADDERS SHALL BE LOCATED INSID: THE BUILDING, ROOF DRAINAGE SHALL UTILIZE INTERPRETATION OF THE BUILDING DESIGN.
INTERATED INTO THE BUILDING DESIGN.
ARCHITECTURALLY INTERATED FLOOR BRAINS SHALL REQUIRE ADDITIONAL ARTICULATION BEYOND PAINT ACCENTS. SECTION 35–1902 (8)(e)(15), ZONING CODE.

SORENING SHALL BE ARCHITECTURALLY INTEGRATEE FOR THE SERVICE ENTRANCE SECTION (SES) AND ALL UTILLITIES. ALL GROUND MOUNTED EQUIPMENT SHALL BE SREENED FROM PUBLIC VIEW BY A CONCRETE CONCRETE AND ASCONEY WALL WITH SOULD CATES, EQUAL TO OR GREATER IN HEIGHT THAN THE MECHANICAL EQUIPMENT. SECTION 35–1902 (B)(e)13, ZONING CODE.

SIGNS REQUIRE A SEPARATE SUBMITTAL AND PERMIT
 ALL ROOF EQUIPMENT, HVAC, TRASH CHUTE AND ANY
 ELEVATOR VENTS, ETC. ARE TO BE BELOW THE LOWEST
 BUILDING PARAPET ELEVATION.

EXTERIOR COLOR SCHEME 1

A LIGHT STUCCO COLOR	BENJAMIN MOORE 2123-70 ICE MIST
B MIDRANGE STUCCO COLOR	DUNN EDWARDS DE6255 WISHING WELL
C DARK STUCCO COLOR	DUNN EDWARDS DE6327 RHINOCEROS
D RAILINGS/CANOPIES /DOORS/ACCENT	DUNN EDWARDS DEA187 BLACK
E ROUGH TEXTURED FIBER CEMENT SIDING	DUNN EDWARDS DET681 MODERN CLASS
F STONE VENEER	CORONADO SAWTOOTH LEDGE WHITE
G BRCK VENEER	SUMMIT FACE BRIC 702 TBL CONCORDE

ELEV #2A

ELEV #2B

ELEV #2B

ELEV #3B

ELEV #1B

H WINDOW/STOREFRONT /CARPORTS

ALTA CHANDLER A-

REZONE RESUBMITTAL 10/02/2020


TOTOLILO	
REVISIONS:	
_	
<u>^</u> -	
<u>3</u> -	
4 -	
<u>\$</u>	

A5.5C

BUILDING 3 - EXTERIOR ELEVATIONS

FINISHED FLOOR HT.

(18) (E) (15) (F)

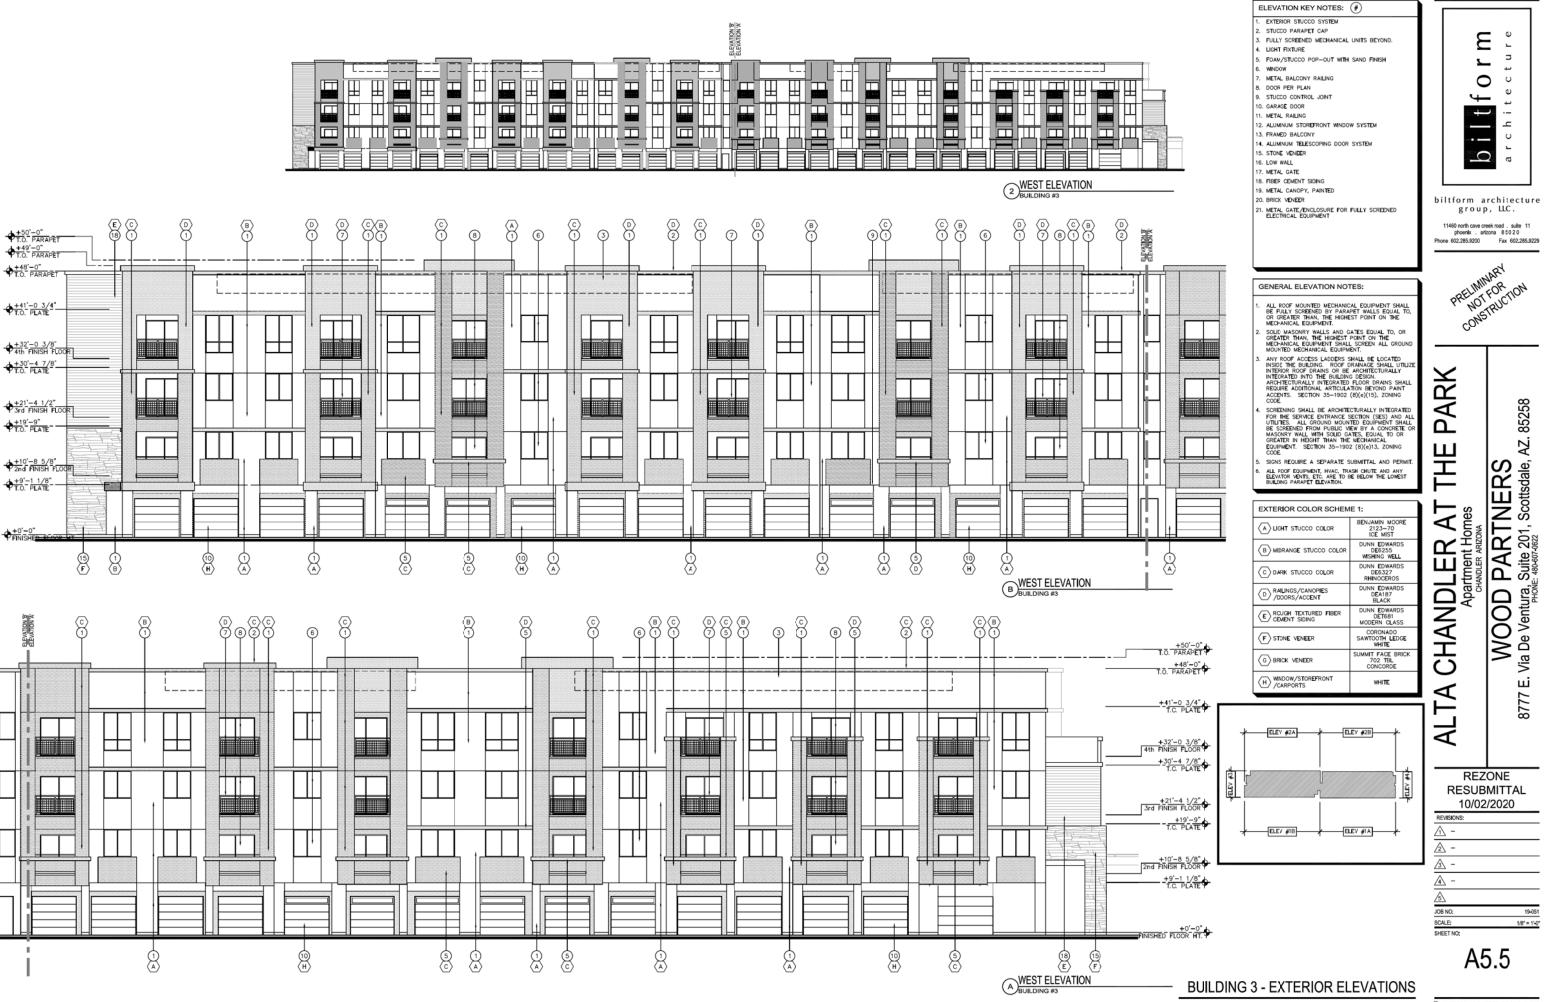

Е -ם 0 C p

biltform architecture group, LLC.

11460 north cave creek road , suite 11 phoenix , arizona 8 5 0 2 0
Phone 602.285.9200 Fax 602.285.9229

PARTNERS
Suite 201, Scottsdale, AZ. 85258

WOOD F. Via De Ventura, S.

REZONE RESUBMITTAL 10/02/2020

10/02/2	-020
REVISIONS:	
<u>^</u> -	
<u>^2</u> -	
<u>3</u> -	
<u> </u>	
<u></u>	
JOB NO:	194
SCALE:	1/8" = 1
SHEET NO-	

A5.5





- 1. EXTERIOR STUCCO SYSTEM
- 2. STUCCO PARAPET CAP
- 3. FULLY SCREENED MECHANICAL UNITS BEYOND.
- 4. LIGHT FIXTURE
- 5. FOAM/STUCCO POP-OUT WITH SAND FINISH
- 6. WINDOW
- 7. METAL BALCONY RAILING 8. DOOR PER PLAN
- 9. STUCCO CONTROL JOINT
- 10. GARAGE DOOR
- 11. METAL RAILING 12. ALUMINUM STOREFRONT WINDOW SYSTEM
 13. FRAMED BALCONY
- 14. ALUMINUM TELESCOPING DOOR SYSTEM 15. STONE VENEER
- 16. LOW WALL 17. METAL GATE
- 18. FIBER CEMENT SIDING
- 19. METAL CANOPY, PAINTED 20. BRICK VENEER
- 21. METAL GATE/ENCLOSURE FOR FULLY SCREENED ELECTRICAL EQUIPMENT

GENERAL ELEVATION NOTES:



biltform architecture group, LLC.

11460 north cave creek road . suite 11 phoenix . arizona 8 50 2 0 Phone 602 285 9200 Fax 602 285 9229

PREIMINARY CONSTRUCTION

PARTNERS
Suite 201, Scottsdale, AZ. 85258

WOOD F 8777 E. Via De Ventura, S

PARK

ш

王

A AT Homes

CHANDLER Apartment H


⋖

F

ALL ROOF MOUNTED MECHANICAL EQUIPMENT SHALL BE FULLY SCREENED BY PARAPET WALLS EQUAL TO OR GREATER THAN, THE HIGHEST POINT ON THE MECHANICAL EQUIPMENT. MECHANICAL EQUIPMENT. SOLID MASONRY WALLS AND GATES EQUAL TO, OR GREATER THAN, THE HIGHEST POINT ON THE MECHANICAL EQUIPMENT SHALL SCREEN ALL GROUNE MOUNTED MECHANICAL EQUIPMENT.

- MUNICID MECHANICAL EQUIPMENT.
 ANY ROOF ACCESS LADDERS SHALL BE LOCATED INSD: THE BUILDING. ROOF DRAINAGE SHALL UTILL INTEROR ROOF BRAINS ON BE ARCHITECTURALLY MERCHANGE SHALL UTILL ARCHITECTURALLY INTERDATED FLOOR BRAINS SHALL REQUIRE ADDITIONAL ARTICULATION BEYOND PAINT ACCENTS. SECTION 35–1902 (8)(e)(15), ZONING CODE.
- . SIGNS REQUIRE A SEPARATE SUBMITTAL AND PERMIT ALL ROOF EQUIPMENT, HVAC, TRASH CHUTE AND ANY ELEVATOR VENTS, ETC. ARE TO BE BELOW THE LOWEST BUILDING PARAPET ELEVATION.

EXTERIOR COLOR SCHEME 1:	
A LIGHT STUCCO COLOR	BENJAMIN MOORE 2123-70 ICE MIST
B MIDRANGE STUCCO COLOR	DUNN EDWARDS DE6255 WISHING WELL
C DARK STUCCO COLOR	DUNN EDWARDS DE6327 RHINOCEROS
D RAILINGS/CANOPIES /DOORS/ACCENT	DUNN EDWARDS DEA187 BLACK
E ROUGH TEXTURED FIBER CEMENT SIDING	DUNN EDWARDS DET681 MODERN CLASS
F STONE VENEER	CORONADO SAWTOOTH LEDGE WHITE
G BRICK VENEER	SUMMIT FACE BRIC 702 TBL CONCORDE
H WNDOW/STOREFRONT /CARPORTS	WHITE

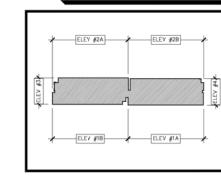



REZONE RESUBMITTAL 10/02/2020

REV	ISIONS:	
Λ	-	
2	-	
3	-	
4	-	
<u>/</u> 5\		
JOB	NO:	19-05
SCAL	.E:	1/8" = 1'-0

A5.6C

BUILDING 3 - EXTERIOR ELEVATIONS

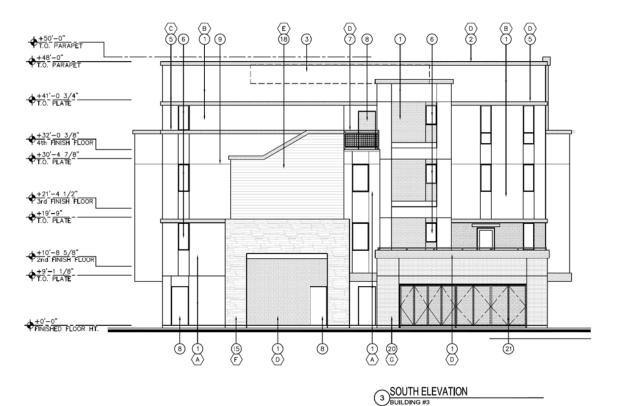

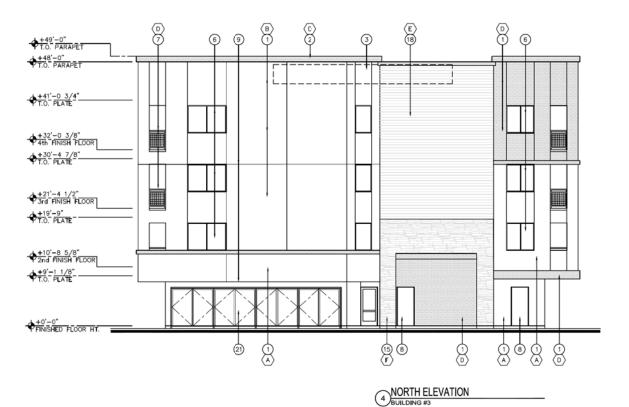

EXTERIOR STUCCO SYSTEM

- STUCCO PARAPET CAP
- FULLY SCREENED MECHANICAL UNITS BEYOND. LIGHT FIXTURE
- FOAM/STUCCO POP-OUT WITH SAND FINISH WINDOW
- METAL BALCONY RAILING DOOR PER PLAN
- 9. STUCCO CONTROL JOINT
- 10. GARAGE DOOR 1. METAL RAILING
- 12. ALUMNUM STOREFRONT WINDOW SYSTEM 13. FRAMED BALCONY
- 14. ALUMNUM TELESCOPING DOOR SYSTEM

GENERAL ELEVATION NOTES:

- 15. STONE VENEER
- 16. LOW WALL 7. METAL GATE
- 18. FIBER CEMENT SIDING
- 19. METAL CANOPY, PAINTED
- 20. BRICK VENEER 21. METAL GATE/ENCLOSURE FOR FULLY SCREENED ELECTRICAL EQUIPMENT

Е t u 0 p

biltform architecture group, LLC.

11460 north cave creek road , suite 11 phoenix , arizona 8 5 0 2 0
Phone 602.285.9200 Fax 602.285.9229

PRELIMINARY CONSTRUCTION

PARTNERS
Suite 201, Scottsdale, AZ. 85258

ALL ROOF MOUNTED MECHANICAL EQUIPMENT SHALL BE FULLY SCREENED BY PARAPET WALLS EQUAL TO, OR GREATER THAN, THE HIGHEST POINT ON THE MECHANICAL EQUIPMENT. SOLID MASONRY WALLS AND GATES EQUAL TO, OR GREATER THAN, THE HIGHEST POINT ON THE MECHANICAL EQUIPMENT SHALL SCREEN ALL GROUNI MOUNTED MECHANICAL EQUIPMENT.

PARK

ш

王

A AT Homes


CHANDLER Apartment H

- MOUNTED MECHANICAL EQUIPMENT.

 ANY ROOF ACCESS LADDERS SHALL BE LOCATED INSIDE THE BUILDING. ROOF DRAINAGE SHALL UTIL. INTERIOR ROOF DRAINS OR BE ARCHITECTURALLY INTEGRATED INTO THE BUILDING DESIGN.

 ARCHITECTURALLY INTEGRATED FLOOR DRAINS SHALL REQUIRE ADDITIONAL ARTICULATION BEYOND PAINT ACCENTS. SECTION 35–1902 (8)(e)(15), ZONING CODE.
- SCHEDNING SHALL BE ARCHITECTURALLY INTEGRATED FOR ME SERVICE ENTRANCE SECTION (SES) AND ALL OFFICIAL GROUND MOUNTED EQUIPMENT SHALL BE SREEMED FROM PUBLIC MEW BY A CONCRETE OF MASCHIRY WALL WITH SOLID CATES, EQUAL TO OR GREATER IN HEIGHT THAN THE MECHANICAL EQUIPMENT. SECTION 35–1902 (8)(e)13, ZONING CODE.
- SIGNS REQUIRE A SEPARATE SUBMITTAL AND PERMIT ALL ROOF EQUIPMENT, HVAC, TRASH CHUTE AND ANY ELEVATOR VENTS, ETC. ARE TO BE BELOW THE LOWEST BUILDING PARAPET ELEVATION.

- 1			
	EXTERIOR COLOR SCHEM	E 1:	
	A LICHT STUCCO COLOR	BENJAMIN MOORE 2123-70 ICE MIST	
	B MIDRANGE STUCCO COLOR	DUNN EDWARDS DE6255 WISHING WELL	
	C DARK STUCCO COLOR	DUNN EDWARDS DE6327 RHINOCEROS	
	D RAILINGS/CANOPIES /DOORS/ACCENT	DUNN EDWARDS DEA187 BLACK	
	E ROUGH TEXTURED FIBER CEMENT SIDING	DUNN EDWARDS DET681 MODERN CLASS	
	F STONE VENEER	CORONADO SAWTOOTH LEDGE WHITE	
	G BRICK VENEER	SUMMIT FACE BRIG 702 TBL CONCORDE	
	H WINDOW/STOREFRONT /CARPORTS	WHITE	

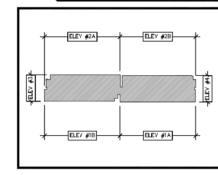



WOOD P 8777 E. Via De Ventura, SI \forall A REZONE RESUBMITTAL


10/02/2020 REVISIONS: <u>∕₂</u> -<u>4</u> -<u></u> JOB NO:


A5.6


EXHIBIT 7

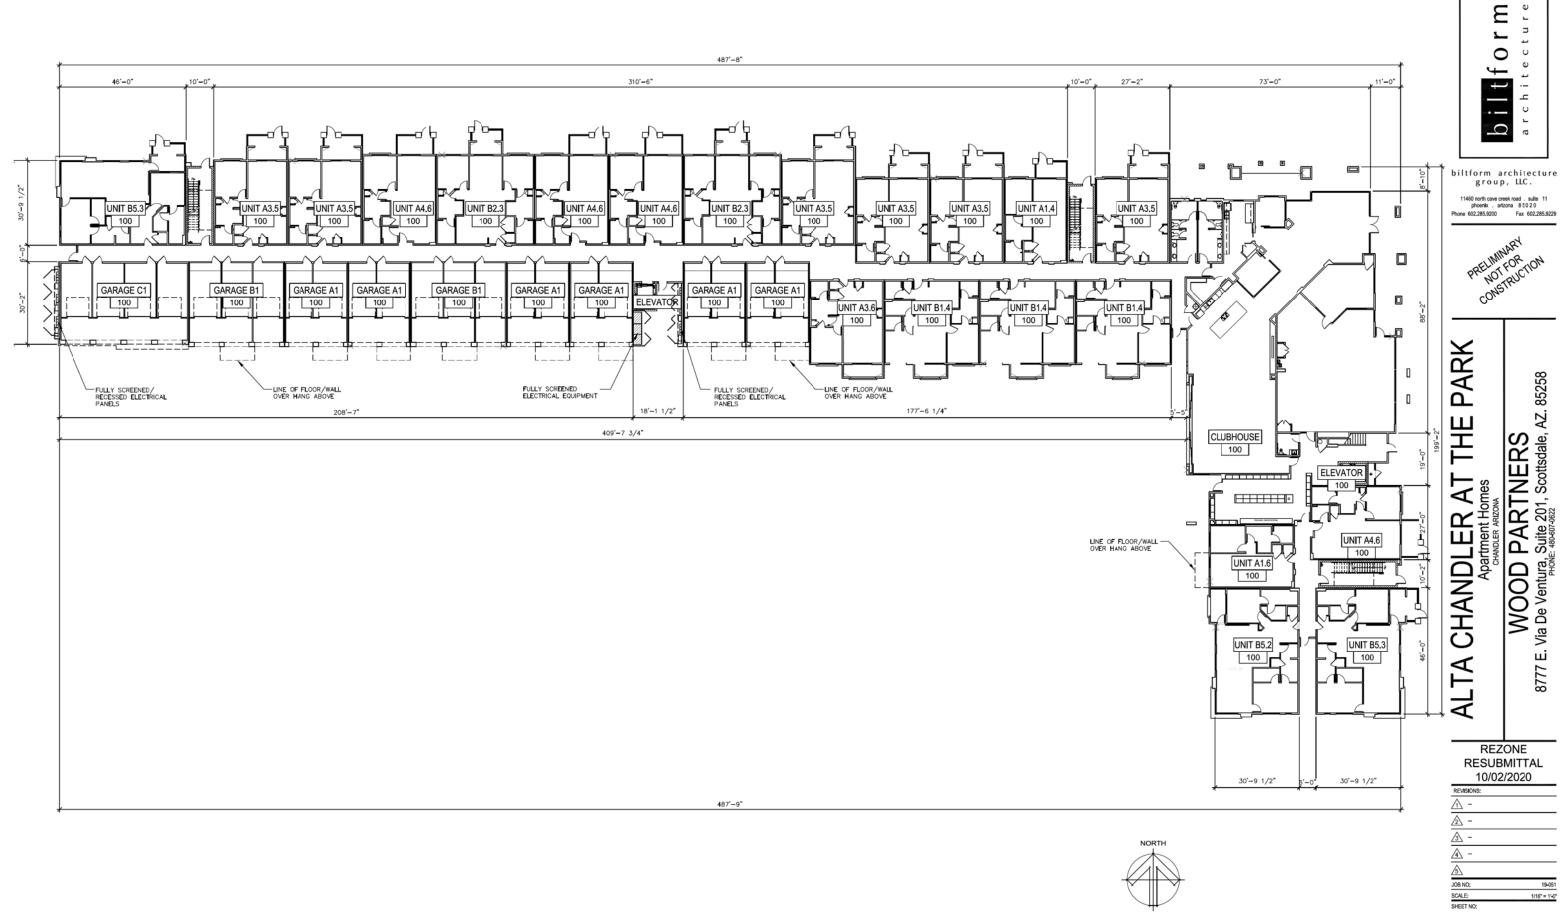


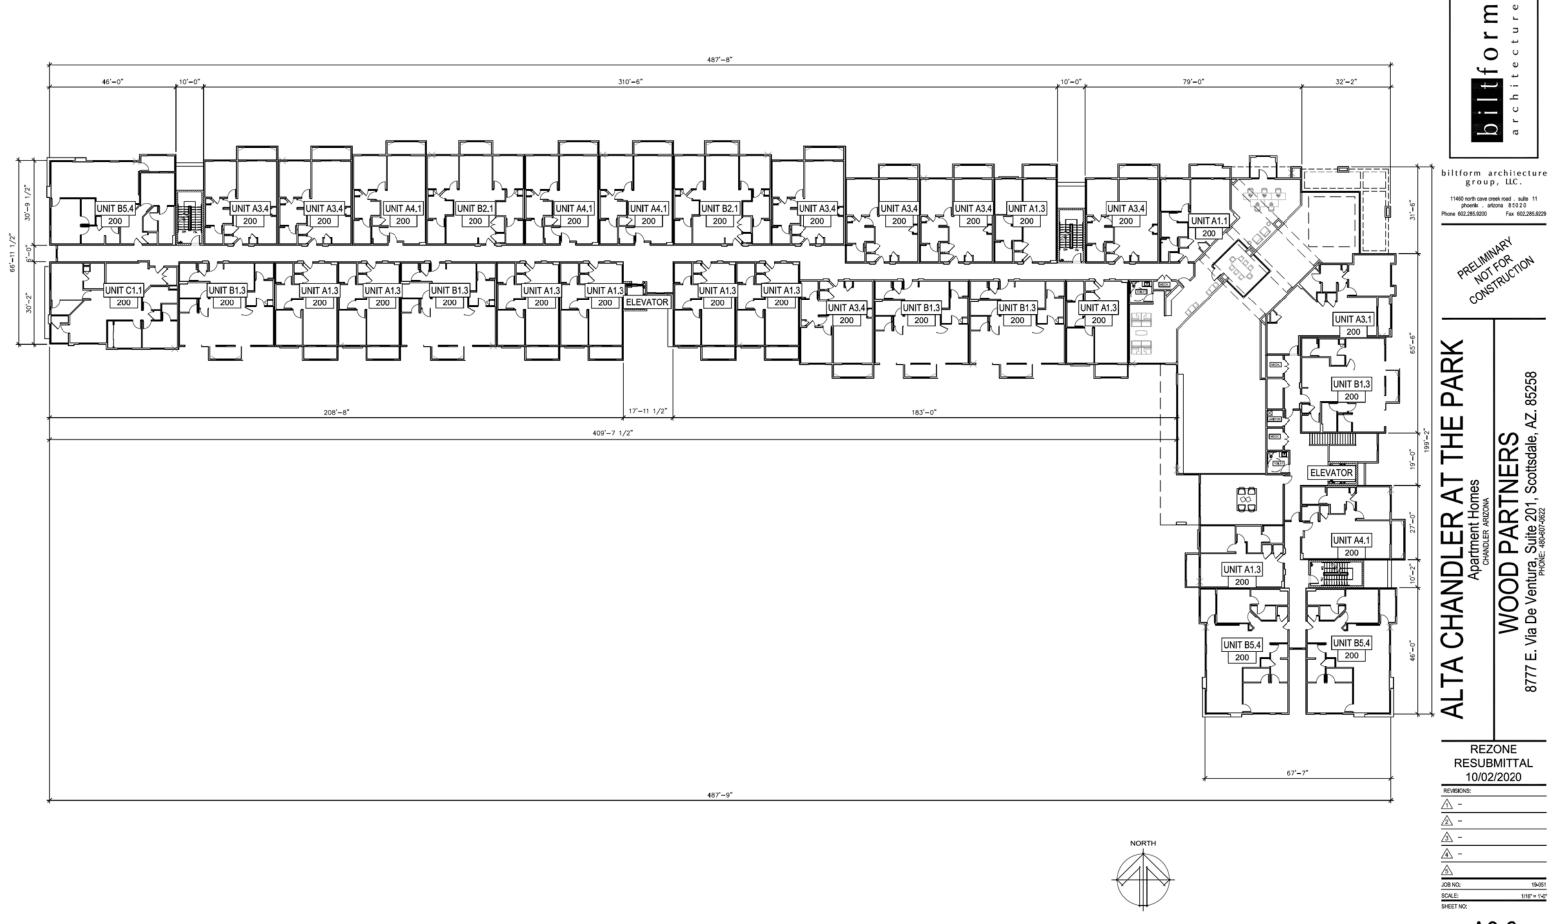


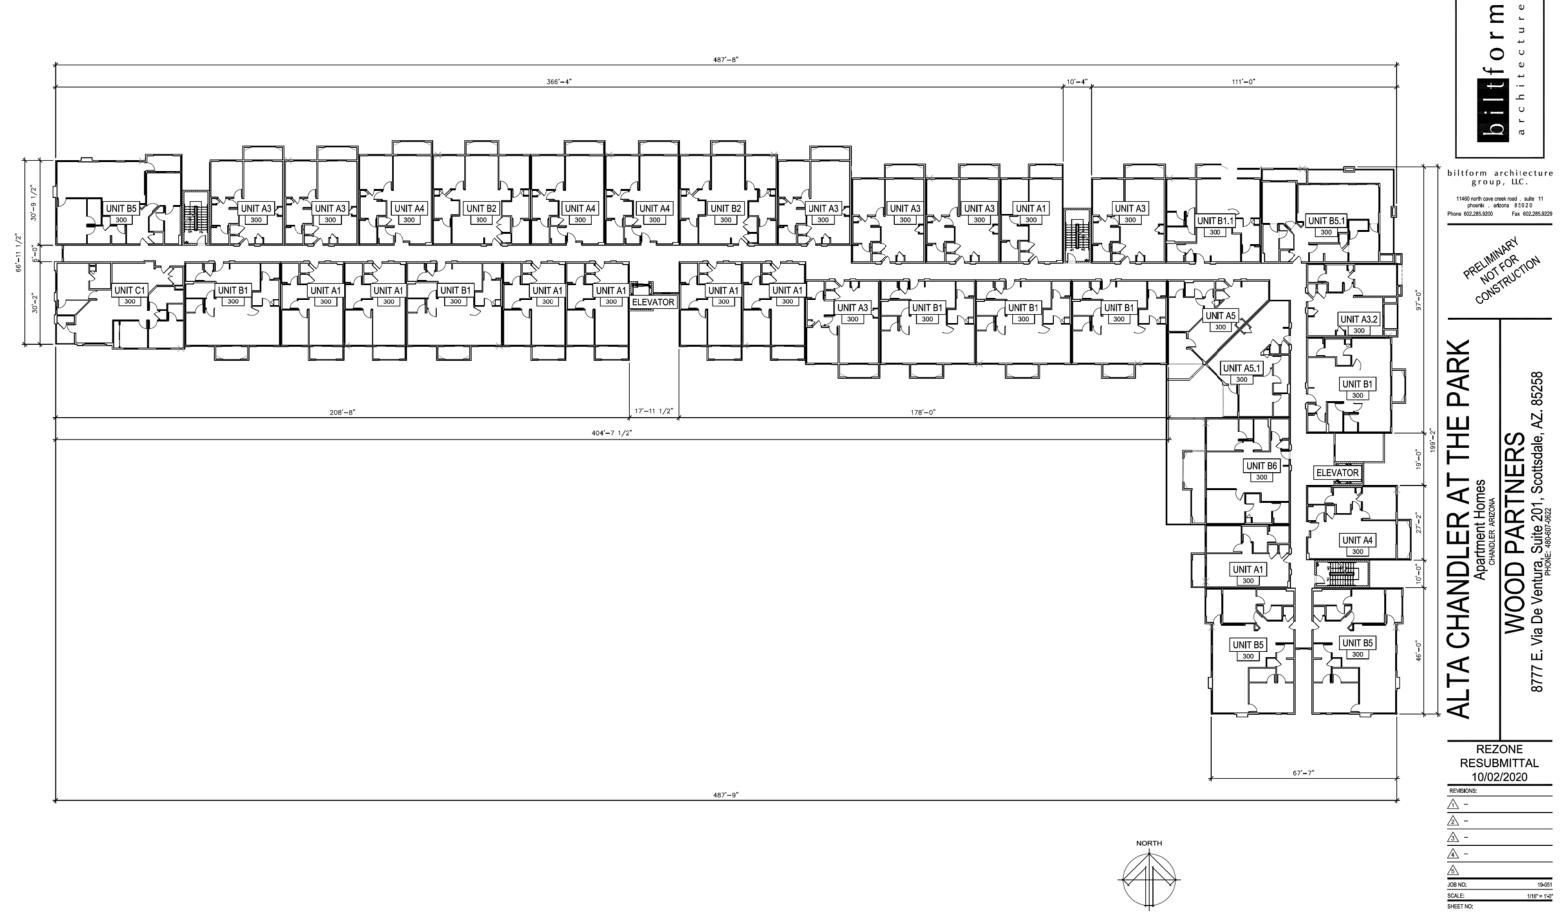


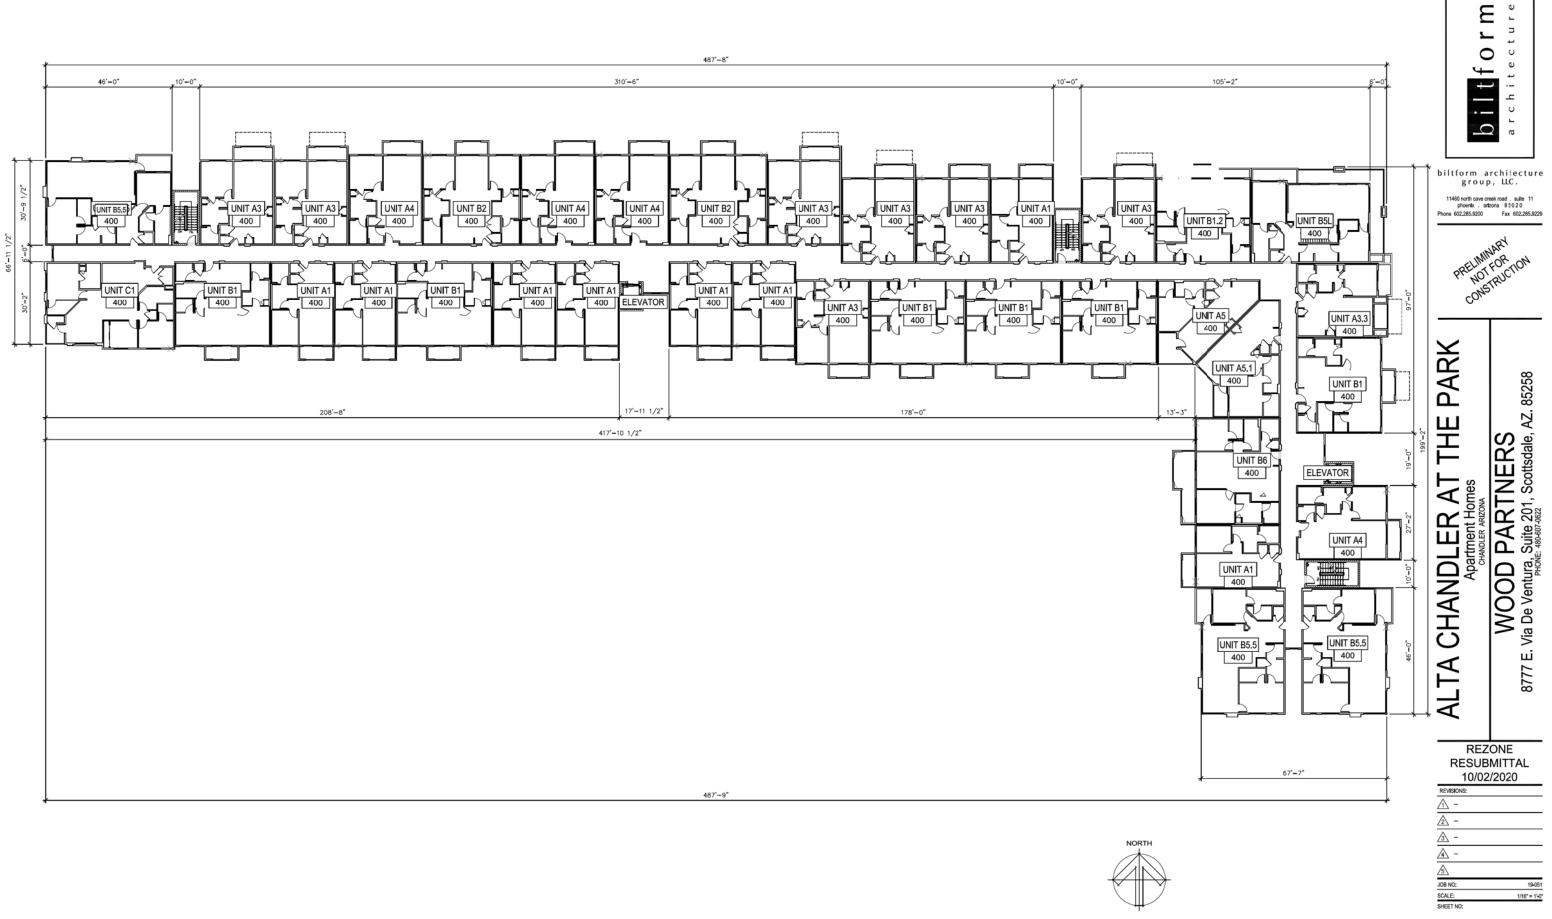

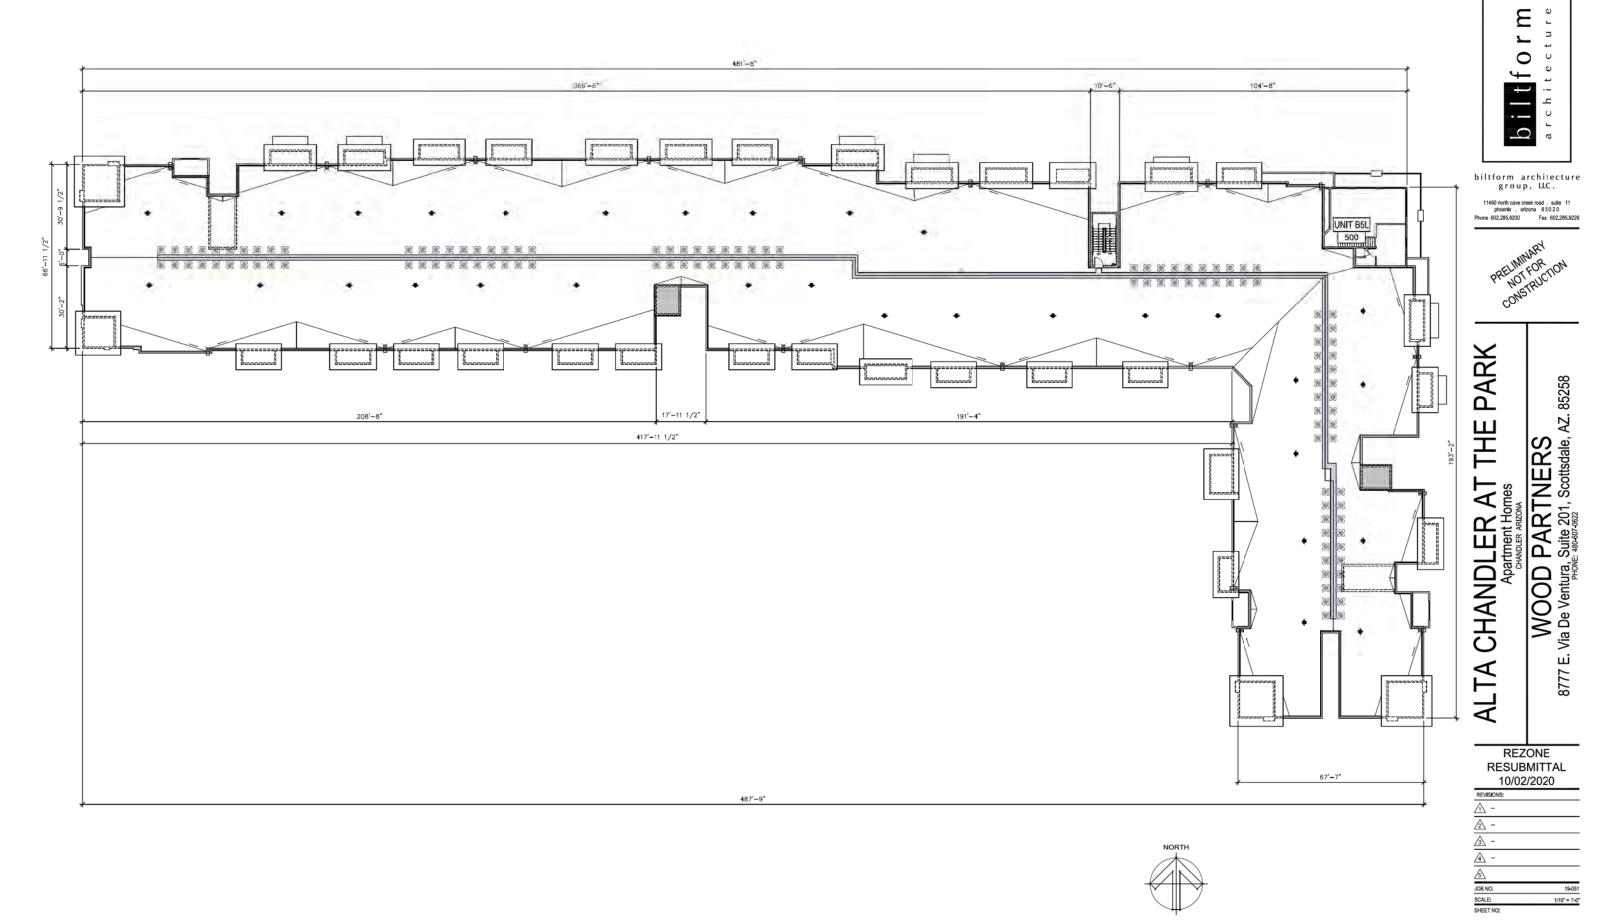

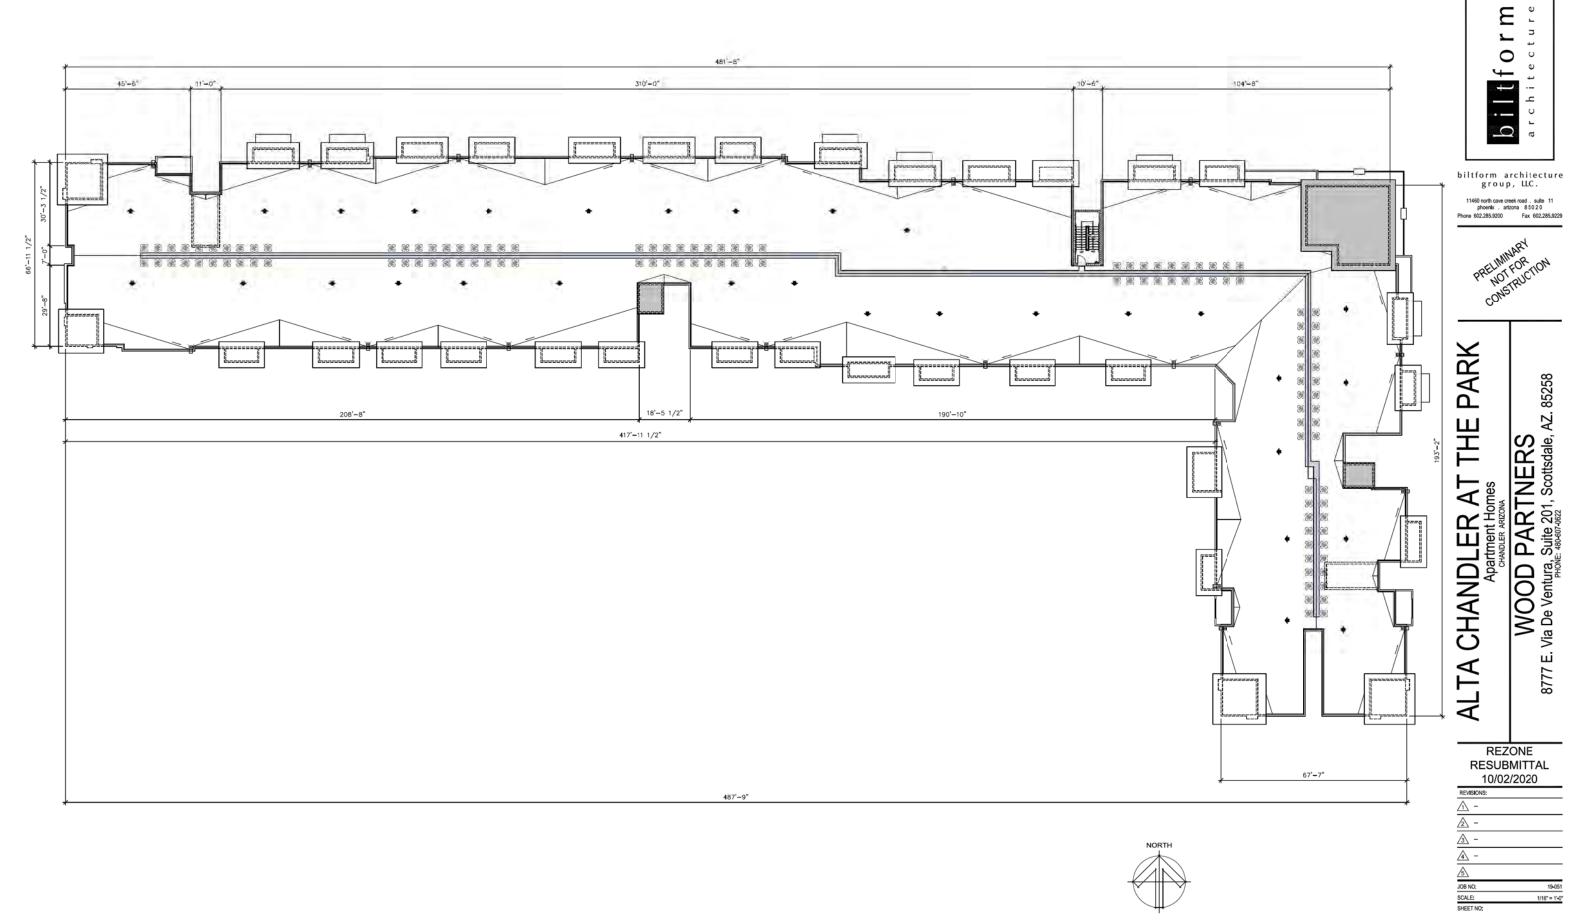

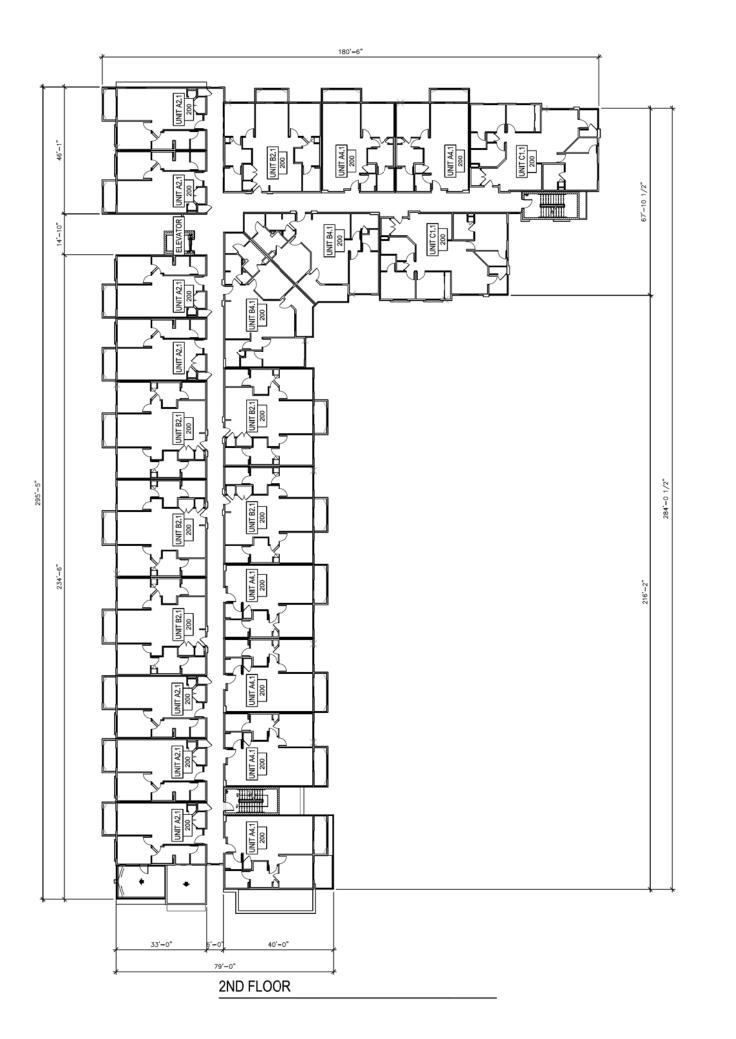

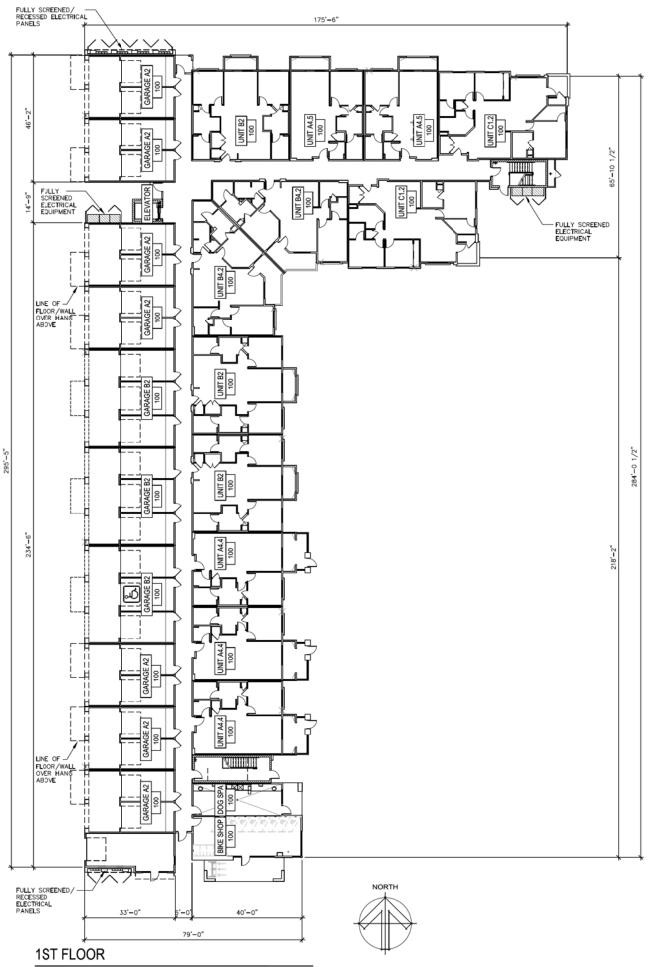

Ε 0 p

biltform architecture group, LLC.

11460 north cave creek road , suite 11 phoenix , arizona 8 5 0 2 0
Phone 602.285.9200 Fax 602.285.9229

PARK


WOOD PARTNERS
8777 E. Via De Ventura, Suite 201, Scottsdale, AZ. 85258 ALTA CHANDLER AT
Apartment Homes


뿓

REZONE RESUBMITTAL 10/02/2020

A4.1

JOB NO:

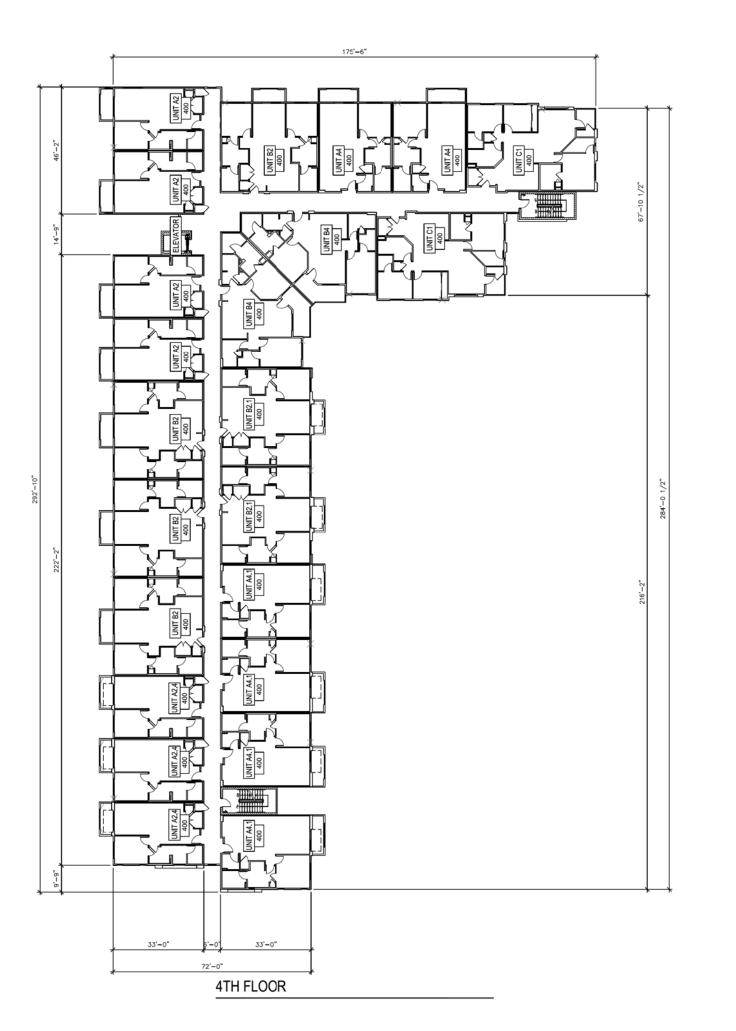

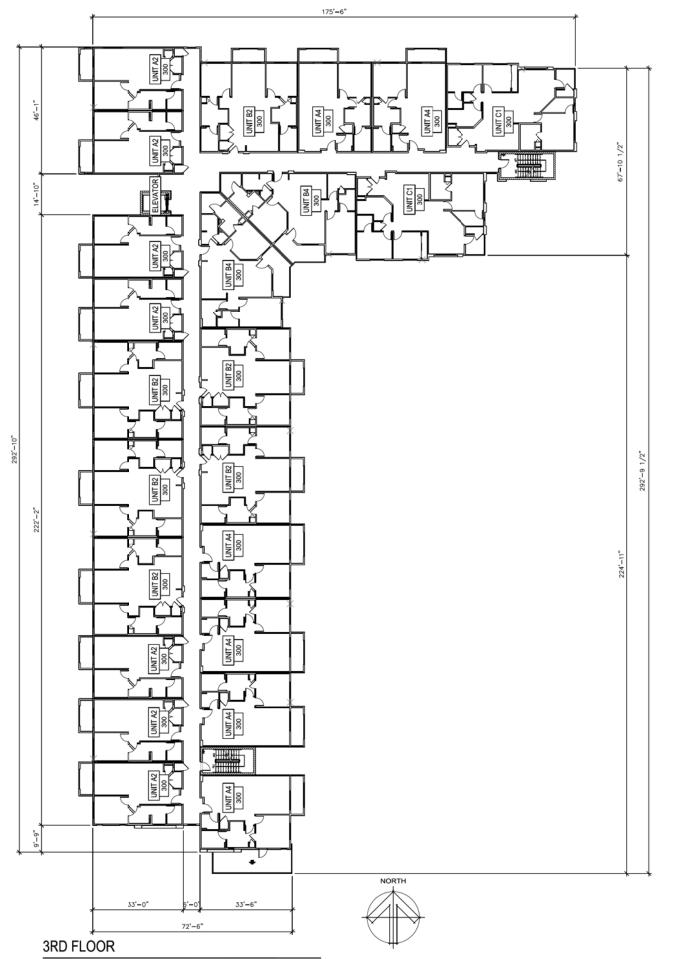

Ε 0 q

biltform architecture group, LLC.

11460 north cave creek road , suite 11 phoenix , aritzona 8 5 0 2 0
Phone 602.285.9200 Fax 602.285.9229

PARK


WOOD PARTNERS
8777 E. Via De Ventura, Suite 201, Scottsdale, AZ. 85258 ALTA CHANDLER AT
Apartment Homes

뿓

REZONE RESUBMITTAL 10/02/2020

JOB NO: SCALE:

A4.2

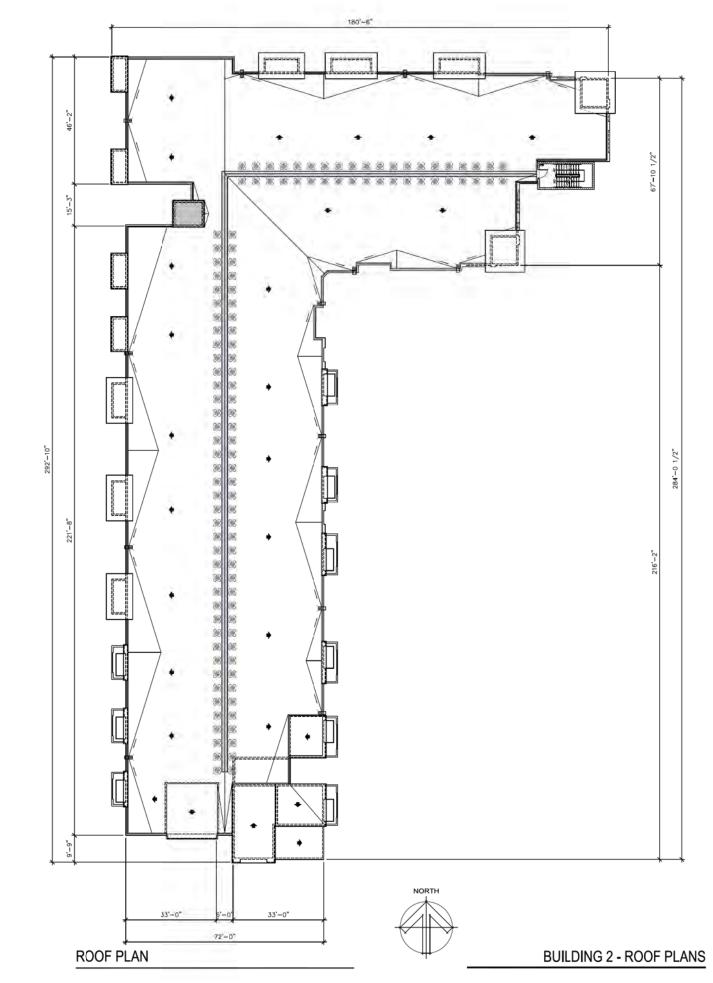



biltform architecture group, LLC.

11460 north cave creek road . suite 11 phoenix . artzona 8 5 0 2 0 Phone 602.285.9200 Fax 602.285.9229

THE PARK

ALTA CHANDLER AT
Apartment Homes
Apartment Homes
Apartment Homes


WOOD PARTNERS
8777 E. Via De Ventura, Suite 201, Scottsdale, AZ. 85258


REZONE RESUBMITTAL

10/02/	2020
REVISIONS:	
<u>^</u> -	
<u>^</u> 2 -	
<u>3</u> -	
<u>A</u> -	
<u>\$</u>	
JOB NO:	19-051
SCALE:	1/16" = 1'-0"
SHEET NO:	

A4.3

© BILTFORM ARCHITECTURE GROUP, INC.

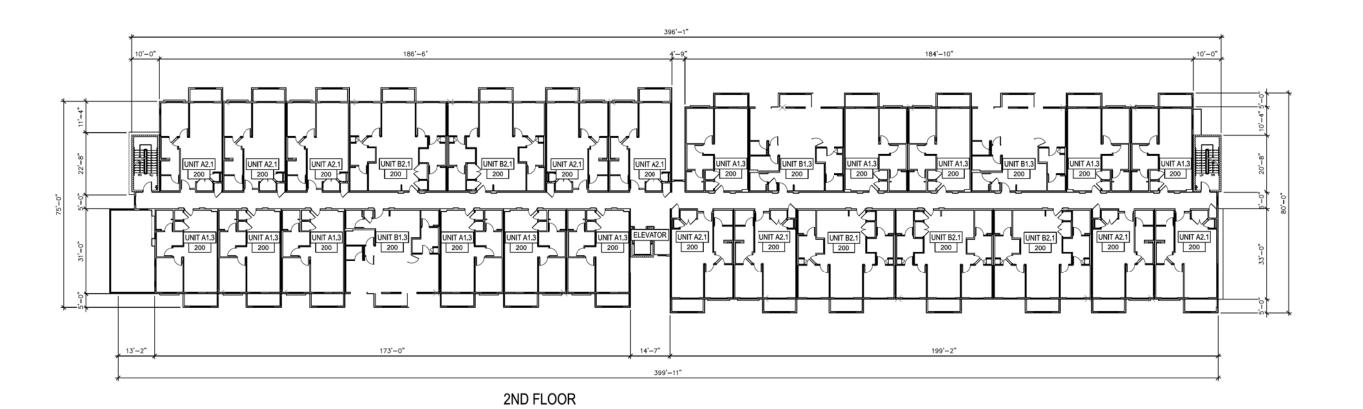

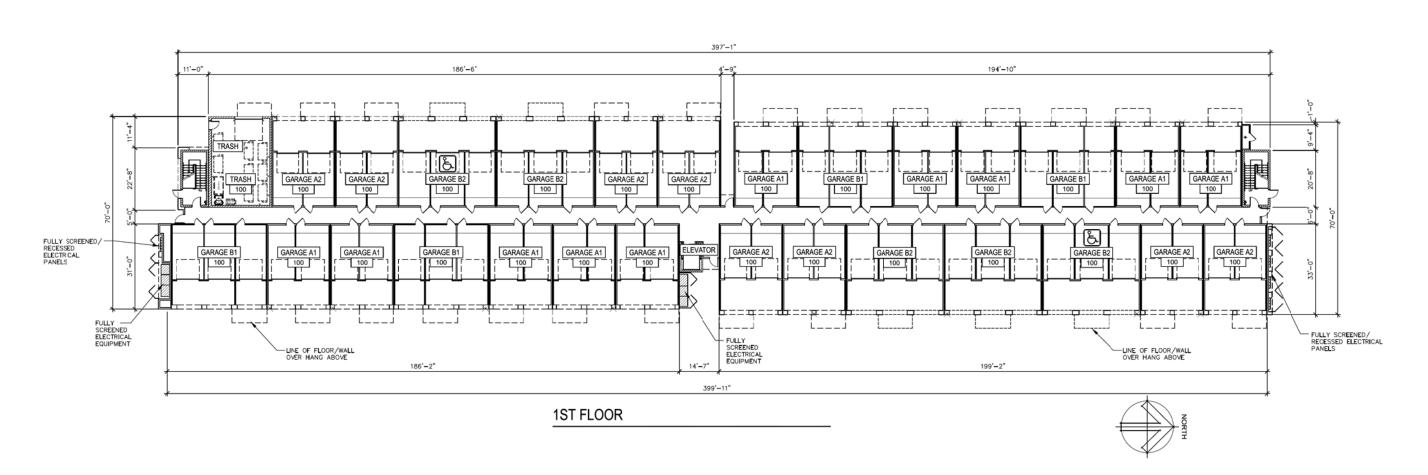

r f 0 p


biltform architecture group, LLC.


11460 north cave creek road , suite 11 phoenitx , arizona 8 5 0 2 0
Phone 602.285.9200 Fax 602.285.9229

ALTA CHANDLER AT THE PARK WOOD PARTNERS
8777 E. Via De Ventura, Suite 201, Scottsdale, AZ. 85258

REZONE RESUBMITTAL 10/02/2020 JOB NO: SCALE:

A5.1

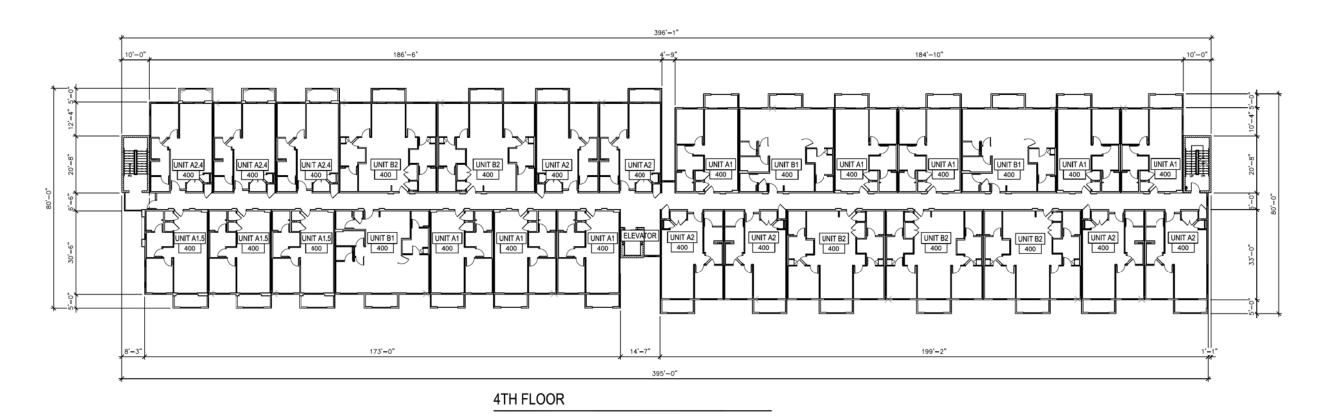

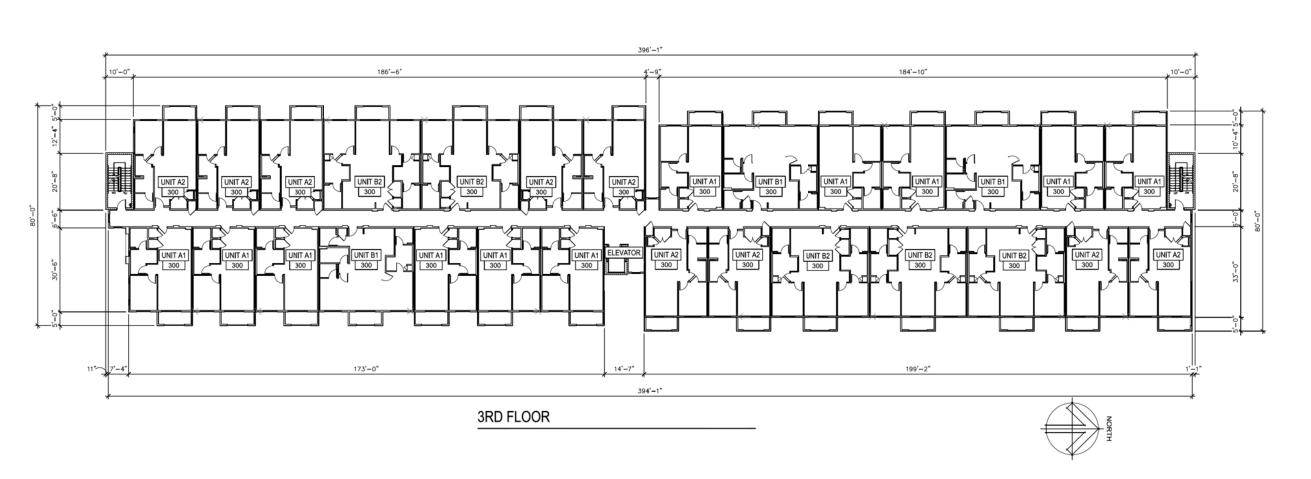



biltform architecture group, LLC.

11460 north cave creek road , suite 11 phoenitx , arizona 8 5 0 2 0 Phone 602.285.9200 Fax 602.285.9229

ALTA CHANDLER AT THE PARK
Apartment Homes
Apartment Homes WOOD PARTNERS
8777 E. Via De Ventura, Suite 201, Scottsdale, AZ. 85258

> REZONE RESUBMITTAL 10/02/2020

REVISIONS:	
<u>^</u> -	
<u>2</u> -	
<u>3</u> -	
<u> </u>	
<u>/5\</u>	
JOB NO:	19-05
SCALE:	1/16" = 1'4

A5.2



biltform architecture group, LLC.

11460 north cave creek road , suite 11 phoenix , arizona 8 5 0 2 0 Phone 602.285.9200 Fax 602.285.9229

WOOD PARTNERS
8777 E. Via De Ventura, Suite 201, Scottsdale, AZ. 85258

ALTA CHANDLER AT THE PARK

REZONE RESUBMITTAL 10/02/2020

RE-VISION

A
B
JOB NO:
SCALE:
SHEET NO:

A5.3

BUILDING 3 - ROOF PLANS

194'-10"

199'-4"


386'-11"


ROOF PLAN


186'-6"


173'-0"


© BILTFORM ARCHITECTURE GROUP, INC.

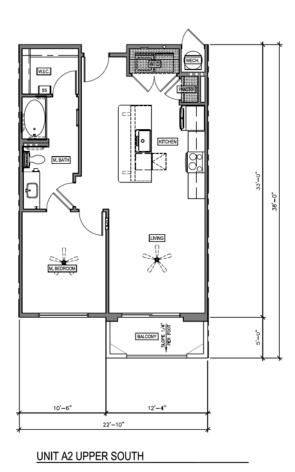


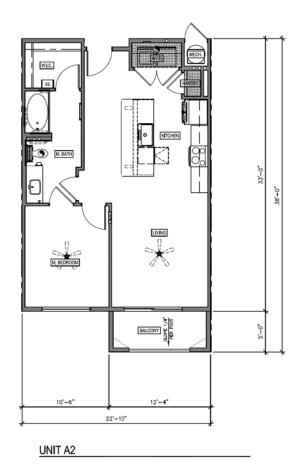

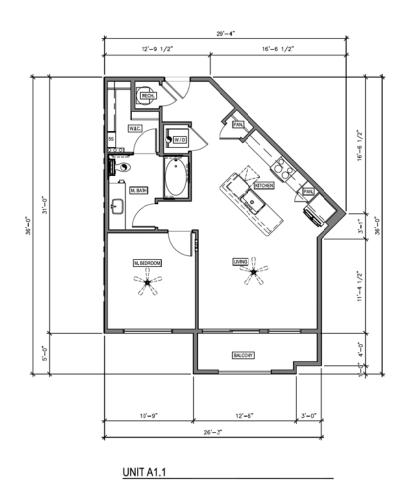

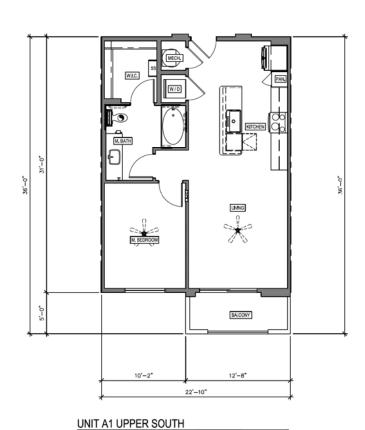

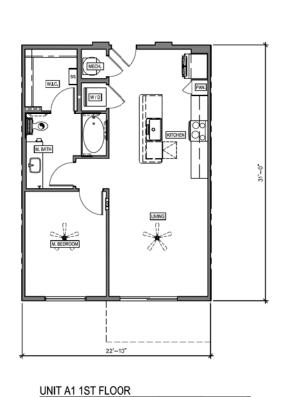

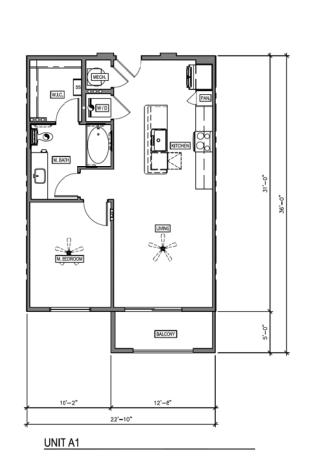


ALTA CHANDLER AT THE PARK
Apartment Homes REZONE

r f o p biltform architecture group, LLC.


11460 north cave creek road . suite 11 phoenix . arizona 8 5 0 2 0
Phone 602.285.9200 Fax 602.285.9229


WOOD PARTNERS
8777 E. Via De Ventura, Suite 201, Scottsdale, AZ. 85258

RESUBMITTAL 10/02/2020

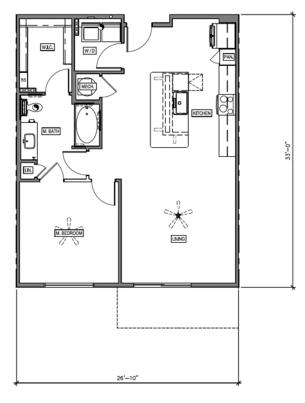





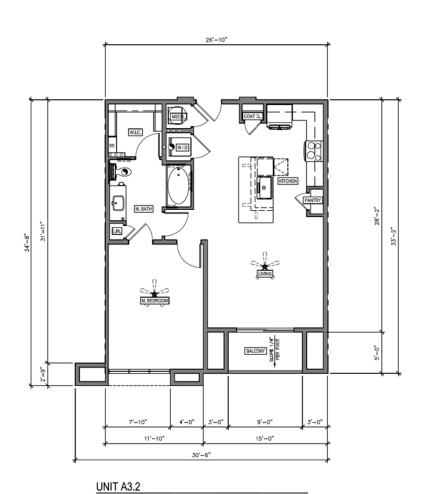

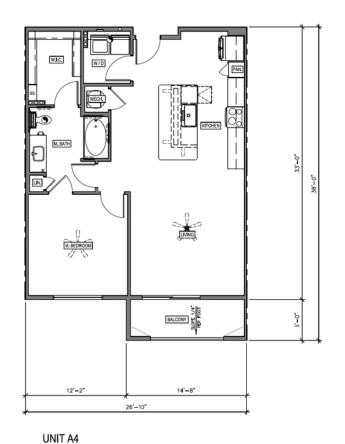


UNIT A4

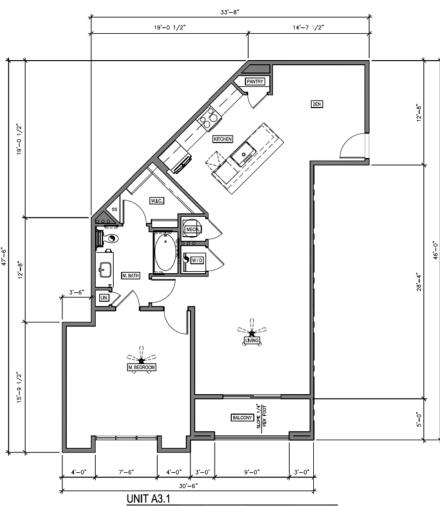

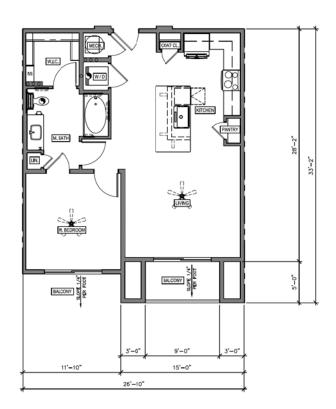

UNIT A3.3

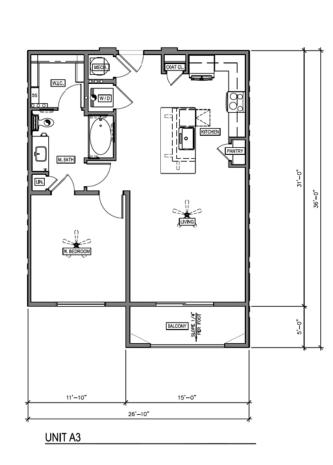

ALTA CHANDLER AT THE PARK

Apartment Homes

WOOD PARTNERS
8777 E. Via De Ventura, Suite 201, Scottsdale, AZ. 85258


Ε


f o


p


biltform architecture group, LLC.


11460 north cave creek road . suite 11 phoenix . arizona 8 5 0 2 0
Phone 602.285.9200 Fax 602.285.9229

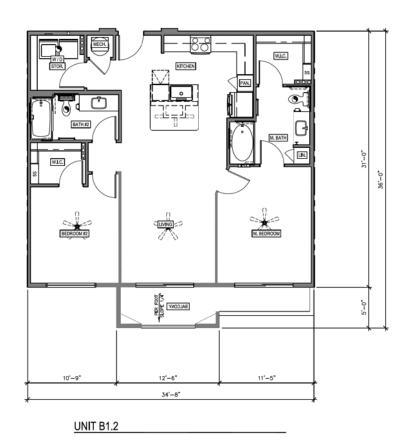


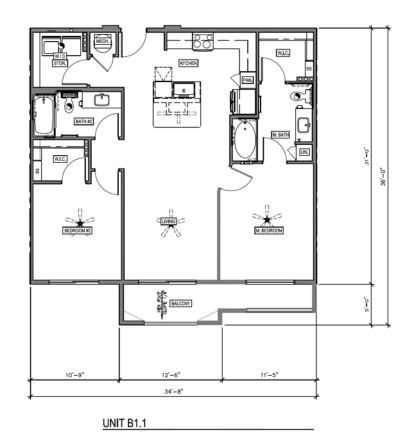

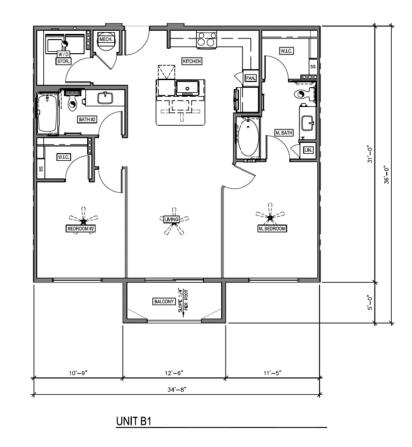

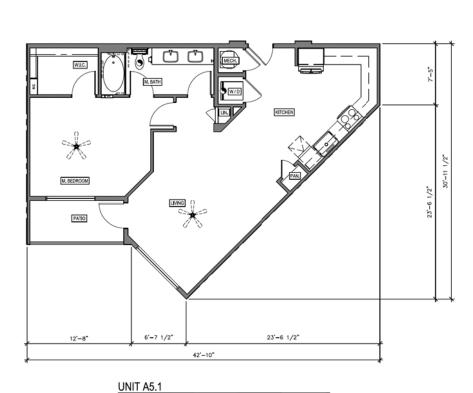

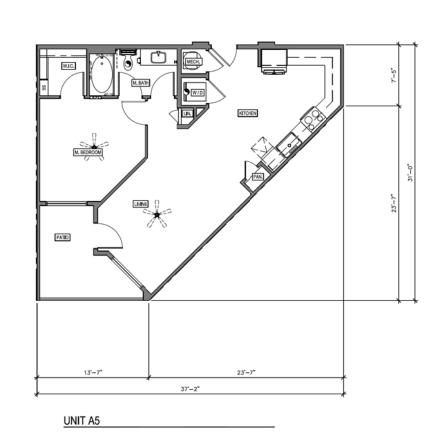

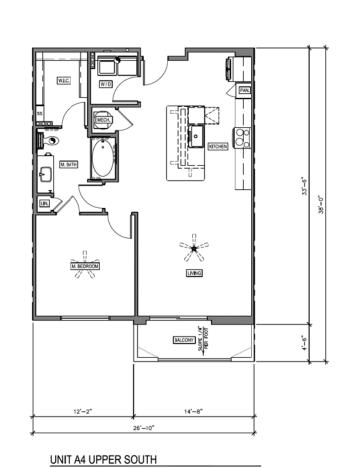



WOOD PARTNERS
8777 E. Via De Ventura, Suite 201, Scottsdale, AZ. 85258


Ε


f o

p


biltform architecture group, LLC.

11460 north cave creek road . suite 11 phoenix . arizona 8 5 0 2 0
Phone 602.285.9200 Fax 602.285.9229

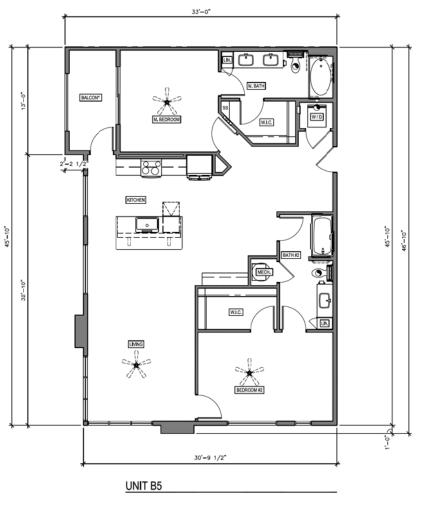


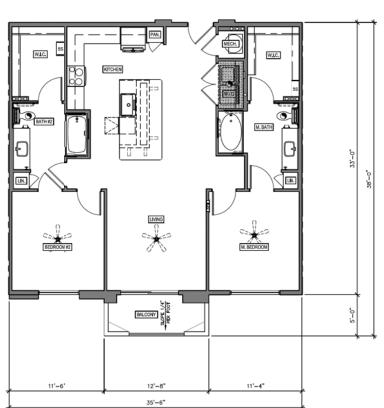



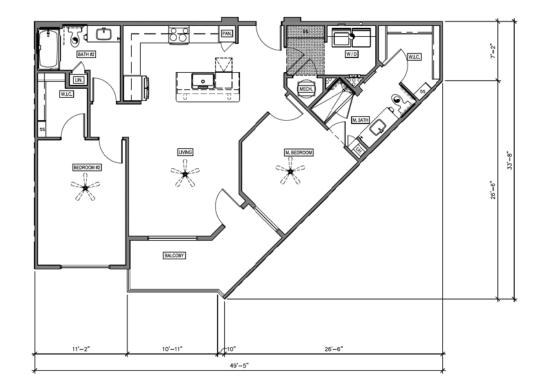

UNIT B4

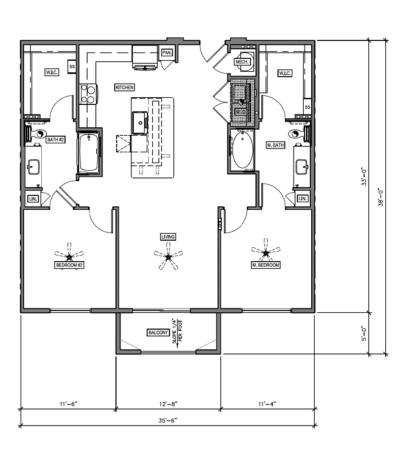

UNIT B2

ALTA CHANDLER AT THE PARK

Apartment Homes
CHANDLER AT THE PARK

ADOD PARTNERS

8777 E. Via De Ventura, Suite 201, Scottsdale, AZ. 85258

r

t fo


q


biltform architecture group, LLC.


11460 north cave creek road . suite 11 phoenix . arizona 8 5 0 2 0
Phone 602.285.9200 Fax 602.285.9229


JOB NO: SCALE: SHEET NO:


REZONE RESUBMITTAL 10/02/2020

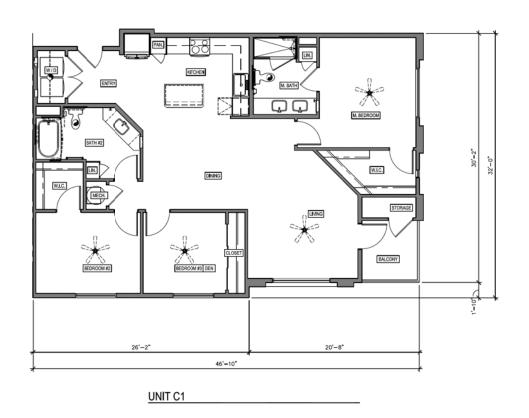

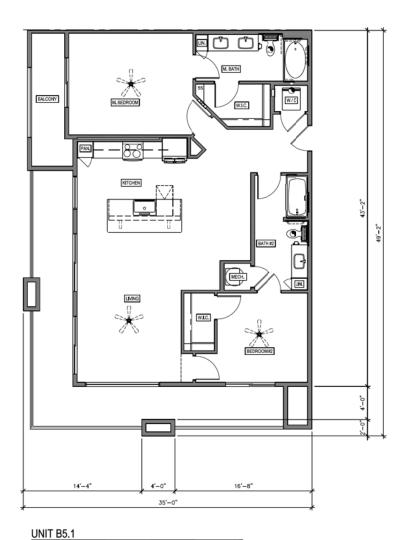

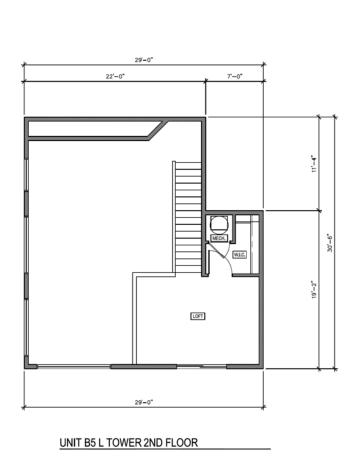

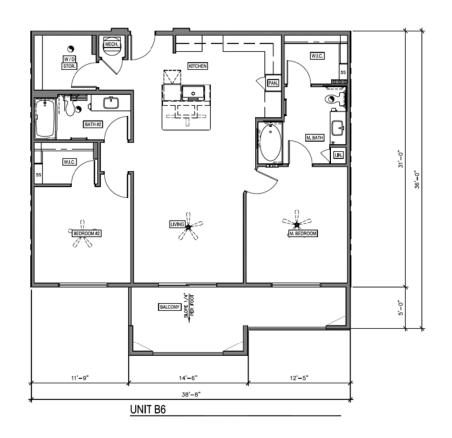

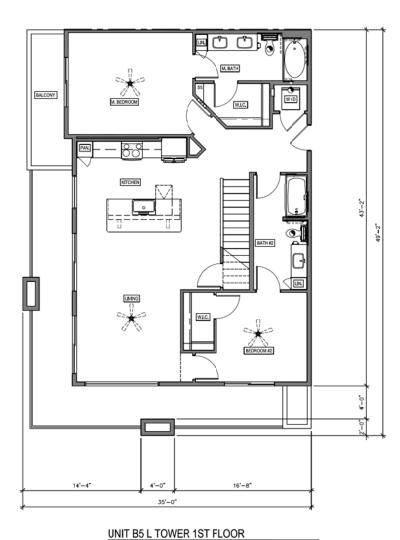



Ε

f o


p

biltform architecture group, LLC.

11460 north cave creek road . suite 11 phoenix . arizona 8 5 0 2 0
Phone 602.285.9200 Fax 602.285.9229

WOOD PARTNERS
8777 E. Via De Ventura, Suite 201, Scottsdale, AZ. 85258

UNIT FLOOR PLANS

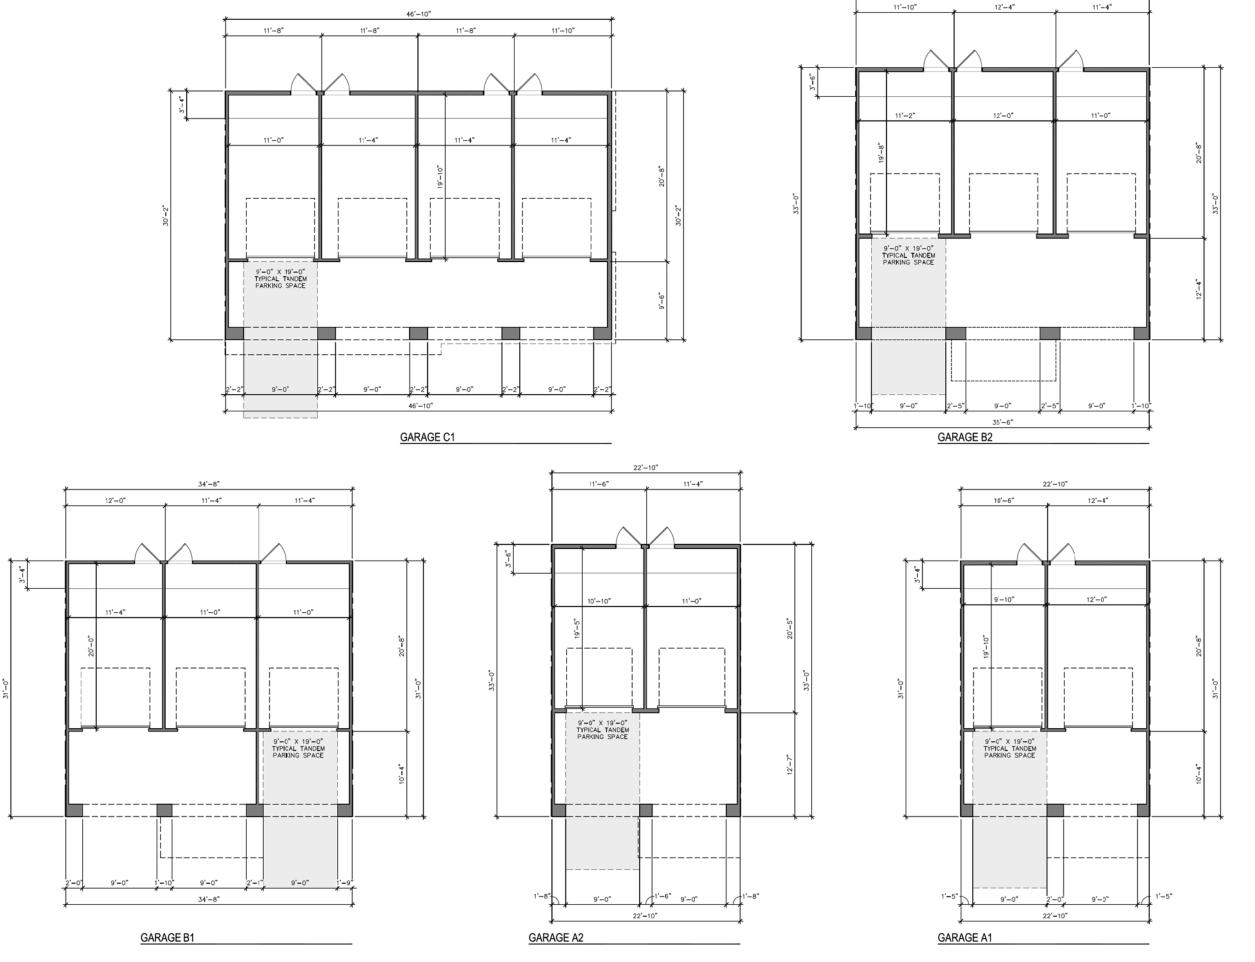

rш t u t fo p

35'-6"

biltform architecture group, LLC.

11460 north cave creek road . suite 11 phoenix . arizona 8 5 0 2 0
Phone 602.285,9200 Fax 602.285,9229

ALTA CHANDLER AT THE PARK
Apartment Homes
Apartment Homes

WOOD PARTNERS
8777 E. Via De Ventura, Suite 201, Scottsdale, AZ. 85258

REZONE RESUBMITTAL

10/02/2020	
REVISIONS:	
<u>^</u> -	
<u>^</u> -	
<u>\$</u> -	
<u>4</u> -	
<u>\$</u>	
IOB NO:	19-05
SCALE: 3/1	6" = 1'-0

Light Stucco Color / Doors - BM 2123-70 Ice Mist



Dark Stucco Color / Doors - DE6327 Rhinoceros



Rough Textured Fiber Cement Siding - **DET681 Moderne Class**



Brick Veneer - Summit Face 702TBL Concorde

Midrange Stucco Color - **DE6255 Wishing Well**



Railings / Canopies / Doors - **DEA187 Black**



Stone Veneer - Coronado Sawtooth Ledge White



Window / Storefront Frames / Carports - White


BUILDING MATERIALS AND COLOR EXHIBIT

Alta Parklane

19-051



11460 north cave creek road . suite 11 phoenix . arizona . 85020 phone 602.285.9200 . fax 602.285.9229

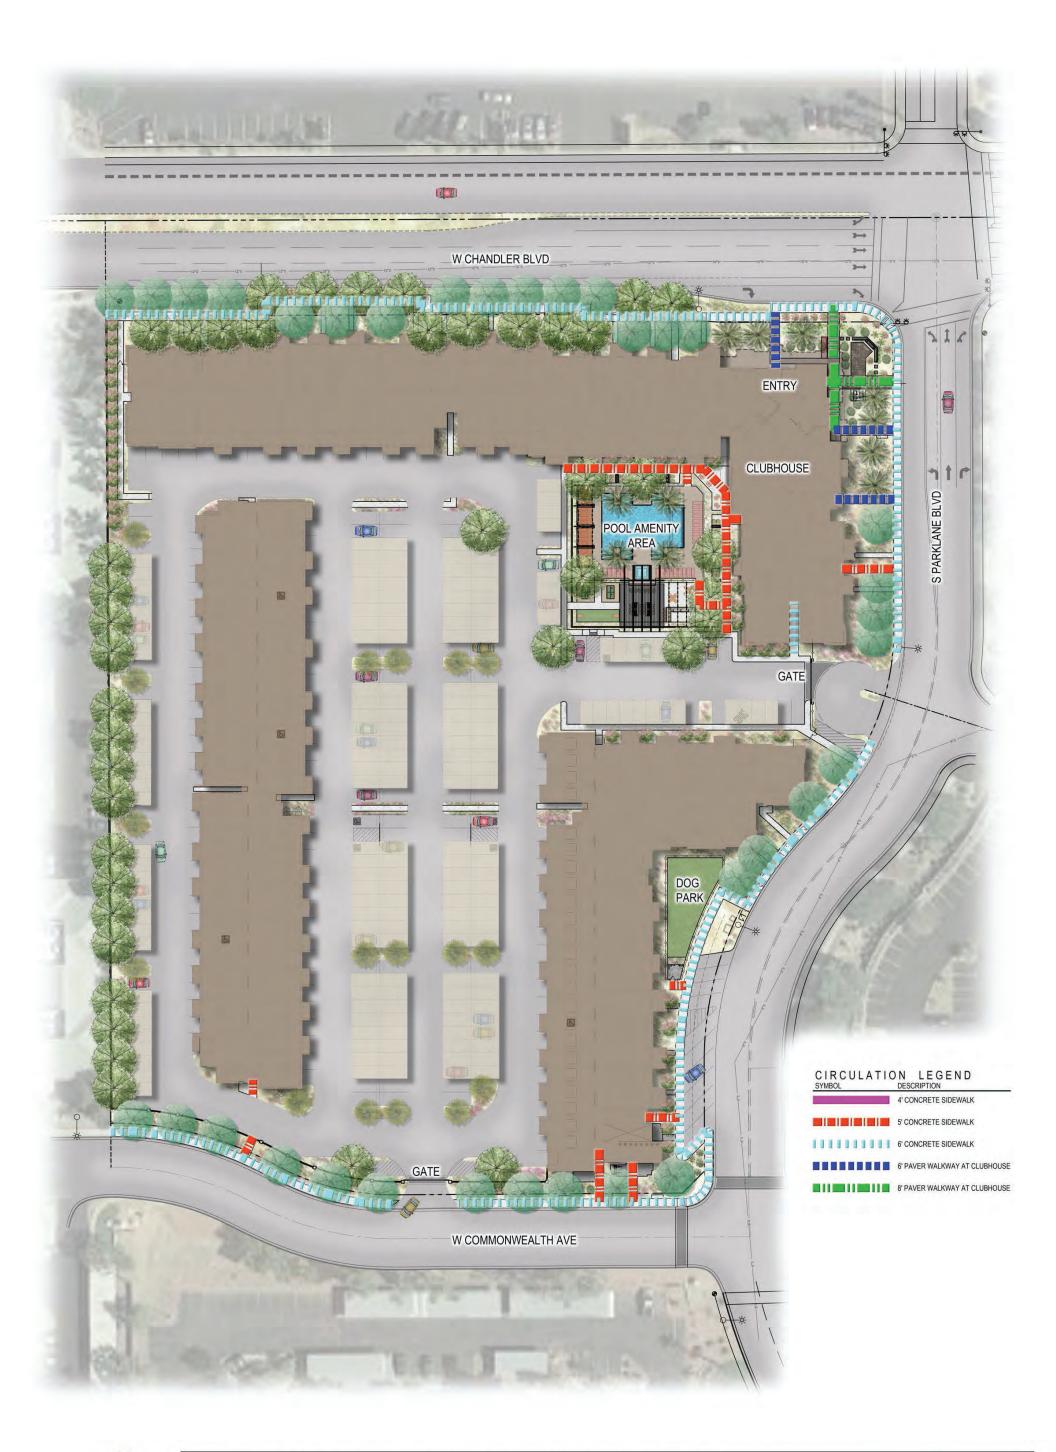












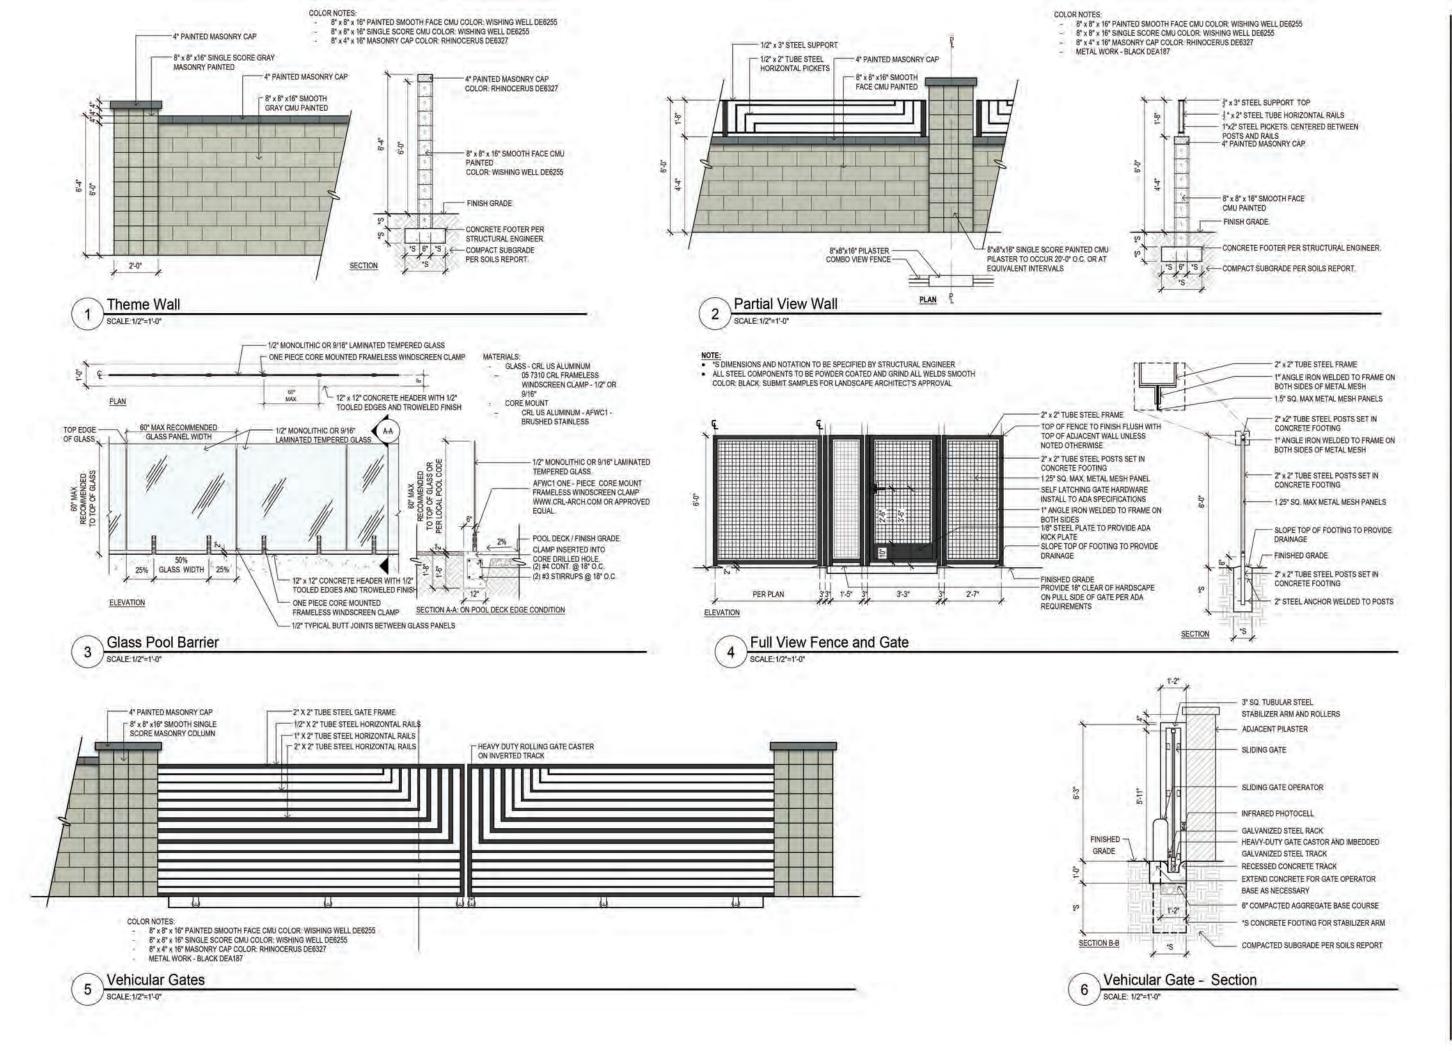

3000 X IOO CUZO



Blvd

Alta Chandler at the Park W. Chandler Blvd and W Parklane Chaster, AZ

Construction Details

1 3

Revis

☐ Bid Set ☐ Construction Title Construction Details

10.02.2020

Per Detail Drawn By CH, CR Checked By

Permit Numbe


Sheet Number

LA6.1







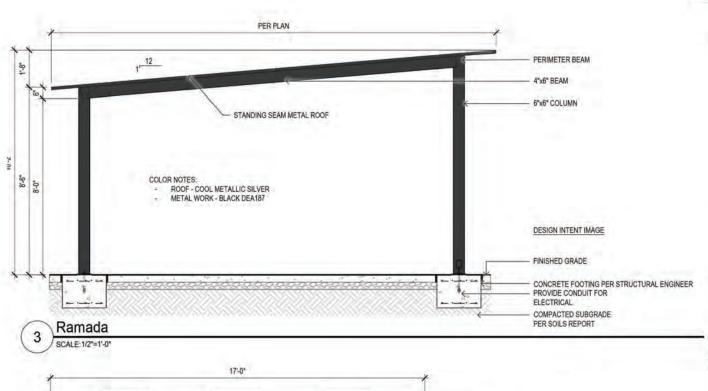

4 BURNER NATURAL GAS GRILL GRANITE COUNTERTOP - TO MATCH INTERIOR GRANITE BBQ MASONRY BUILD UP, WITH PAINTED MEDIUM SAND STUCCO FINISH GRILL ACCESS DOORS BBQ TIMERS, CONTROLS, AND SHUT OFFS TOE KICK COLOR NOTES: GRANITE COUNTERTOP TO MATCH INTERIOR GRANITE STUCCO - WISHING WELL DE6255 GRILLS AND DOORS TO BE STAINLESS STEEL

BBQ Grills at Outdoor Dining Area

SCALE: 1/2"=1'-0"

528 007



Alta Chandler at the Park W. Chandler Blvd and W Parklane Blvd

Construction Details

Revision A Issued for
Design Dev. 10.02.2020
Progress
City Submittal
Bid Set
Construction

Title Construction Details

10.02.2020

Per Detail Drawn By

Checked By

Permit Number

Sheet Number LA6.2

☐ Progress
☐ City Submitta
☐ Bid Set
☐ Construction

Title Construction Details

10.02.2020 Scale Drawn By

Permit Number

Sheet Number

LA6.3

STAMPED ASPHALT NOTES: Ethos Enterprises

POLYMERIC GROUT AT PAVERS -

3" CLASS " B " CONCRETE

4" COMPACTED ABC -

Paver Walkway

SURFACING SYSTEM

THICKNESS AS REQUIRED, REFER TO

THICKNESS AS REQUIRED - REFER TO

ENGINEERING (2" MIN. TYPICAL FOR

COMPACTED GRANULAR MATERIAL

DEPTH AS REQUIRED BY LOCAL

IN-SITU MATERIAL. REMOVE SOFT AREAS AND REPLACE WITH WELL

CITY OF CHANDLER SPECIFICATIONS.

FINISHED POST PRINT DEPTH

AS PER SPECIFICATION

ASPHALT PAVEMENT

OVERLAY/RESURFACING)

MUNICIPALITY CODES

BASE

SUBGRADE

SOILS REPORT


APPROXIMATELY 3/8", PATTERN

550 W. Baseline Rd. SUITE 102-238, MESA, AZ 85210

P: 480-321-7142 WEB:www.ethos.enterprises

STREETPRINT (or equal) PATTERN (FIELD) - ASHLAR SLATE FIELD COLOR: SLATE


INSTALLATION TO BE COMPLETED IN ACCORDANCE WITH MANUFACTURER'S SPECIFICATIONS AND CITY OF PEORIA SPECIFICATIONS

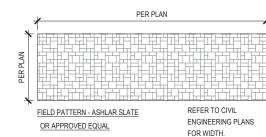

GRADED, COMPACTED GRAVEL PER


Stamped Asphalt At Pedestrian Crossings


SECTION

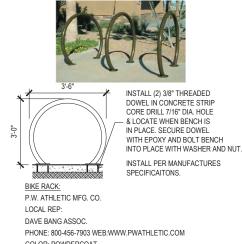

COLOR: POWDERCOAT BLACK METAL MODEL: 1700-00 / M3 OR APPROVED EQUAL ROUND-UP BIKE RACK

Bicvcle Parking

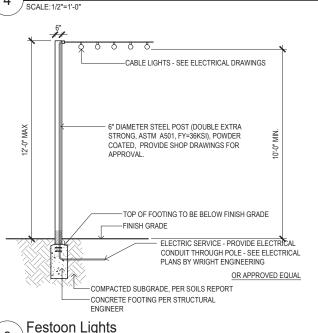

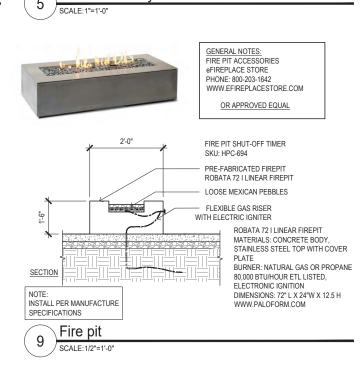

MANUFACTURER: BELGARD


SIZE: 3 1/2"x 7 7/8"x 2 3/8"FIELD


INSTALL PER MANUFACTURER SPECS. OR APPROVED EQUAL

PATTERN: RUNNING BOND

MODEL: HOLLAND STONE

COLOR: SABLE BLEND

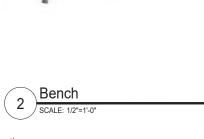

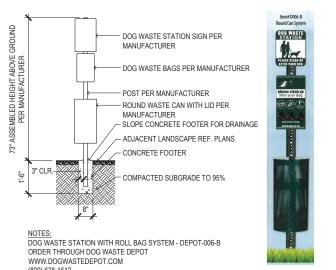

(800) 678-1612

Pet Waste Station



MANUFACTURER: P & P IMPORTS MODEL: CH-01-LED-WHITE (GLOW IN THE DARK) STYLE:

BEAN BAG TOSS

TAIL GATE SIZE





DOG WATER STATION NOTES:
1. CONTRACTOR TO PROVIDE CUT SHEETS & SHOP DRAWINGS TO LANDSCAPE ARCHITECT FOR REVIEW & APPROVAL PRIOR TO PURCHASE OR INSTALLATION.

DOG WATER STATION MATERIALS:
- MANUFACTURER: LIVING THE DOGS LIFE
WEB: WWW.LIVINTHEDOGLIFE.COM MODEL: DOGGIE WATER STATION DL-1000-SS PRODUCT DIM: 32" H x 6-5/8" DIA. x 19-5/8" W 32 LBS. PROVIDE 1" POTABLE WATER SUPPLY FROM IRRIGATION MAINLINE, PROVIDE 1 1/4" DRAIN LINE TO SUMP IN ADJACENT LANDSCAPE AREA.

Doggie Water Station



MANUFACTURER GAME TABLES ONLINE JOOLA DRIVE INDOOR/OUTDOOR TABLE TENNIS COLOR:

PIG PONG TABLE





OR APPROVED EQUAL

OR APPROVED EQUAL

BENCH NOTES: LANDSCAPE FORMS

MODEL: NEOROMANICO, 69"

COLOR: WOOD DSTMA

MOUNTING METHOD

OR APPROVED EQUAL

OR APPROVED EQUAL

OR APPROVED EQUAL

TRASH RECEPTACLE NOTES:

http://www.landscapeforms.com/

LANDSCAPE FORMS

MODEL: FGP LITTER

COLOR: WOOD DSTMA

MOUNTING METHOD


OR APPROVED EQUAL

SURFACE

ALTA CHANDLER AT THE PARK

PRELIMINARY GRADING, DRAINAGE, WATER & SEWER PLAN CHANDLER, ARIZONA

A PORTION OF SECTION 32, TOWNSHIP 1 SOUTH, RANGE 5 EAST OF THE GILA AND SALT RIVER MERIDIAN, MARICOPA COUNTY, ARIZONA

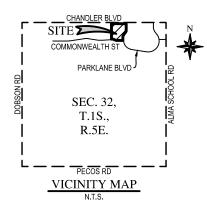

WOOD

PATEL

www.wcodpatel.com ARIZONA811 Arizona Blue Stake, Inc.

602,335,8500

ALTA CHANDLER AT THE PARK
PRELIMINARY GRADING, DRAINAGI
WATER & SEWER PLAN
CHANDLER, ARIZONA
COVER SHEET

PLEASE REFER TO SHEET 2 FOR DRAINAGE STATEMENT.

DRAINAGE STATEMENT


RETENTION CALCULATIONS

PLEASE REFER TO SHEET 2 FOR RETENTION CALCULATIONS.

PROJECT DESCRIPTION

CHANDLER AND PARKLANE IS A PROPOSED 291-UNIT MULTI-FAMILY DEVELOPMENT WITHIN CHANDLER AT THE SOUTHWEST CORNER OF CHANDLER BLVD. AND PARKLANE BLVD. THE PROJECT WILL CONSIST OF THREE (3) 4-STORY APARTMENT BUILDINGS WITH UNIT GARAGES, COVERED AND UNCOVERED PARKING, LANDSCAPE, HARDSCAPE AND UTILITY IMPROVEMENTS.

PLEASE REFER TO SHEET 2 FOR LEGEND AND LIST OF ABBREVIATIONS.

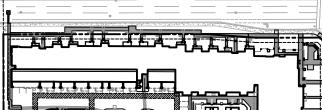

W. CHANDLER BLVD

PARKLANE BLVD

W. COMMONWEALTH ST

KEY MAP

INDEX MAP LEGEND



GRADING & DRAINAGE



WATER & SEWER

SHEET INDEX

SHEET 1 COVER SHEET SHEET 2 NOTES

SHEET 3 PRELIMINARY GRADING & DRAINAGE PLAN SHEET 4 PRELIMINARY GRADING & DRAINAGE PLAN SHEET 5 PRELIMINARY WATER & SEWER PLAN SHEET 6 PRELIMINARY WATER & SEWER PLAN

SURVEY NOTE

TOPOGRAPHIC SURVEY, BOUNDARY AND EASEMENT INFORMATION USED FOR THIS PROJECT IS FROM THE ALTA/NSPS LAND TITLE SURVEY FOR LOTS 8 & 9 OF BOOK 475 PAGE 24, MCR. MARICOPA COUNTY, ARIZONA. PREPARED BY HELIX ENGINEERING, LLC DATED AUGUST 7,

BASIS OF BEARING

MONUMENT LINE OF CHANDLER BLVD FROM A BRASS CAP IN HAND-HOLE AT ARROWHEAD RD., N89°57'00"E, 2638.64' TO BRASS CAP IN HAND-HOLE AT ALMA SCHOOL RD. (FROM PLATT BK. 275, PG. 24. MCR). (SEE SURVEY NOTE)

BENCHMARK

CMCN 33 - C.O.C. BRASS CAP FLUSH AT THE INTERSECTION OF MAGGIO WAY & APACHE DR. NAVD88, ELEV. 1204.67.

OWNER / DEVELOPER

8777 EAST VIA DE VENTURA, SUITE 201 SCOTTSDALE, ARIZONA 85258 CONTACT: CLAY RICHARDSON PHONE: (480) 567-0520

ENGINEER

WOOD, PATEL & ASSOCIATES, INC. 2051 WEST NORTHERN AVENUE, SUITE 100 PHOENIX, ARIZONA 85021 CONTACT: DEREK C. NICHOLS, P.E. PHONE: (602) 335-8500 FAX: (602) 335-8580


ARCHITECT

BILTFORM ARCHITECTURE GROUP, LLC 11460 NORTH CAVE CREEK ROAD, SUITE 11 PHOENIX, ARIZONA 85020 CONTACT: JIM APPLEGATE PHONE: (602) 285-9200

PROJECT SITE DATA

ASSESSOR PARCEL NUMBER(S): 303-75-580, 303-75-614, 303-75-613 PROJECT SITE ADDRESS: WEST CHANDLER BOULEVARD CHANDLER, ARIZONA 85224 PROJECT SITE AREA(S): NET AREA = 6.49 AC DISTURBED AREA = 6.5± AC ZONING: PAD

PUBLIC UTILITIES CITY OF CHANDLER SEWER CITY OF CHANDLER ELECTRIC SALT RIVER PROJECT TELEPHONE CENTURYLINK NATURAL GAS SOUTHWEST GAS COX COMMUNICATIONS CABLE TV

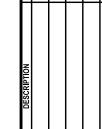



DRAINAGE STATEMENT

- THE PROJECT SITE IS NOT LOCATED IN A SPECIAL FLOOD HAZARD AREA.
- THE EXISTING SITE RECEIVES OFFSITE FLOW FROM THE ADJACENT HALF-STREETS OF PARKLANE BLVD. AND COMMONWEALTH BLVD.
- THE EXISTING SITE DOES NOT RECEIVE OFFSITE FLOW FROM THE ADJACENT HALF-STREET OF CHANDLER BLVD. RETENTION FOR THIS AREA IS PROVIDED WITHIN A RETENTION BASIN AT THE SOUTHEAST CORNER OF CHANDLER BLVD. AND ARROWHEAD DR.
- THE PROJECT IS PROVIDED RETENTION FOR ALL ONSITE AREAS AS WELL AS THE ADJACENT HALF-STREETS OF PARKLANE BLVD. AND COMMONWEALTH BLVD. RETENTION WILL $\underline{\mathsf{NOT}}$ BE PROVIDED FOR THE ADJACENT HALF-STREET OF CHANDLER BLVD.
- RETENTION IS PROVIDED FOR THE 100-YEAR, 2-HOUR STORM EVENT PLUS 10% ADDITIONAL VOLUME.
- EXTREME STORM OUTFALLS THE SITE AT THE SOUTHWEST CORNER OF THE SITE INTO COMMONWEALTH BLVD. AT THE ELEVATION OF 1199.9±.

RETENTION CALCULATIONS

C x (P/12) x A x 1.1

DESIGN STORM: 100-YEAR, 2-HOUR + 10% ADDITIONAL

RAINFALL DEPTH, P: 2.20 INCHES

0.5 x (TOP CONTOUR AREA + BOTTOM CONTOUR AREA) x (TOP VP (BASIN) = CONTOUR ELEVATION - BOTTOM CONTOUR ELEVATION)

V_P (PIPE) = π x (DIAMETER/2)2 x (LENGTH)

REQUIRED RETENTION VOLUME


BASIN ID	CONTRIBUTING DRAINAGE AREA, A (SF)	WEIGHTED RUNOFF COEFFICIENT, C*	RETENTION VOLUME REQUIRED, VR (CF)	
А	213,846	0.80	34,500	
В	100,955	0.80	16,287	
TOTAL	314,801		50,787	

^{*}WEIGHTED COEFFICIENTS DETERMINED USING C=0.80 FOR MULTIFAMILY.

PROVIDED RETENTION VOLUME

	TROVIDED RETENTION VOLUME							
	BASIN ID	TOP CONTOUR AREA (SF)	BOTTOM CONTOUR AREA (SF)	TOP CONTOUR ELEVATION	BOTTOM CONTOUR ELEVATION	RETENTION VOLUME PROVIDED, VP (CF)	RETENTION VOLUME REQUIRED, VR (CF)	AS-BUILT RETENTION VOLUME PROVIDED (CF)
	A1	1,099	417	1200.50	1200.00	379	SEE TOTAL	
	A2	A2 440 LF - 10'Ø CMP				34,557	BELOW	
	Α		TOTAL O	F A1 + A2		34,936	34,500	
	В		210 LF -	10'Ø CMP		16,493	16,287	
_	TOTAL					E1 420	E0 707	

TOTAL 51,429 50,787

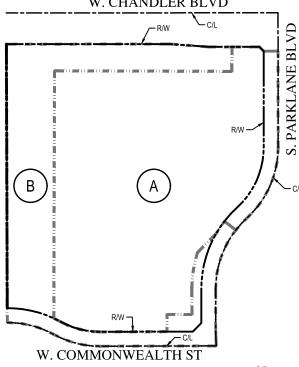

PRELIMINARY DRAINAGE MAP





FLOOD INSURANCE RATE MAP (FIRM) INFORMATION

MAP	COMMUNITY	PANEL	SUFFIX	DATE OF	FIRM	BASE FLOOD ELEVATION
NUMBER	NUMBER	NUMBER		FIRM	ZONE	(IN AO ZONE, USE DEPTH)
	040044	2744	М	11/4/2015	х	N/A

FEMA FIRM NOTE (ZONE X)

ACCORDING TO FEMA FLOOD INSURANCE RATE MAPPING, THE SUBJECT PROPERTY IS LOCATED IN 'OTHER AREAS' "ZONE X". ZONE X IS DESCRIBED AS: "AREAS DETERMINED TO BE OUTSIDE THE 0.2% ANNUAL CHANCE FLOODPLAIN."

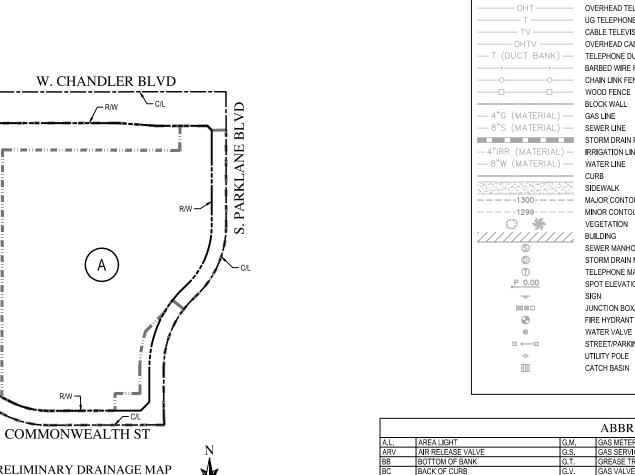

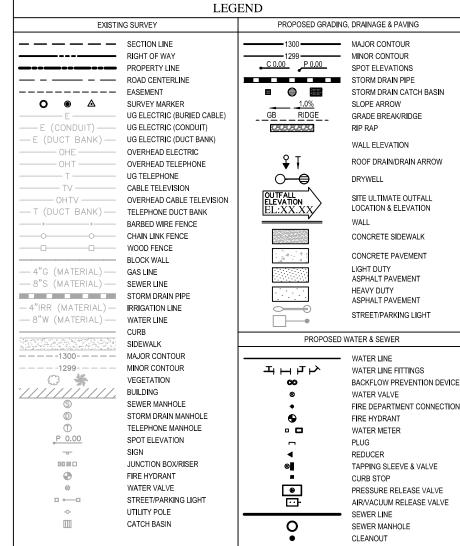

			ABBREVIATIONS		
A.L.	AREA LIGHT	G.M.	GAS METER	S.J.B.	STREET LIGHT JUNCTION BOX
ARV	AIR RELEASE VALVE	G.S.	GAS SERVICE	S.L.	STREET LIGHT
BB	BOTTOM OF BANK	G.T.	GREASE TRAP	S.L.E.	SLOPE EASEMENT
BC	BACK OF CURB	G.V.	GAS VALVE	S.L.M.	STREET LIGHT MAST ARM
BF	BOTTOM OF FOOTING ELEVATION	HDPE	HIGH DENISTY POLYETHYLENE	SMH	SEWER MANHOLE
B.P.	BARRIER POST	HWE	HIGH WATER ELEVATION	SS	SEWER SERVICE
BSL	BUILDING SETBACK LINE	INV	INVERT ELEVATION	STA	STATION
BW	BOTTOM OF WALL ELEVATION	I.V.	IRRIGATION VALVE	S.V.E.	SIGHT VISIBILITY EASEMENT
С	CONCRETE ELEVATION	I.V.B.	IRRIGATION VALVE BOX	S.V.T.	SIGHT VISIBILITY TRIANGLE
C.B.	CATCH BASIN	L.E.	LANDSCAPE EASEMENT	S.W.E.	SIDEWALK EASEMENT
CF	CUBIC FEET	LF	LINEAR FEET	TB	TOP OF BANK
C.J.B.	CABLE TV JUNCTION BOX	LFF	LOWEST FINISHED FLOOR ELEVATION	TC	TOP OF CURB
CL	CENTER LINE	M.U.E.	MULTI-USE EASEMENT	TF	TOP OF FOOTING ELEVATION
C.O.	CLEAN OUT	NG	NATURAL GROUND ELEVATION	T.J.B.	TELEPHONE JUNCTION BOX
CO	CURB OPENING	Р	PAVEMENT ELEVATION	TRW	TOP OF RETAINING WALL ELEVATION
C.T.R.	CABLE TV RISER	PAD	FINISHED PAD ELEVATION	TW	TOP OF WALL ELEVATION
DE	DRAINAGE EASEMENT	P.A.E.	PRIVATE ACCESS EASEMENT	U.E.	UTILITY EASEMENT
DG	DECOMPOSED GRANITE	P.L.	PARKING LIGHT	UG	UNDERGROUND
DIP	DUCTILE IRON PIPE	PL	PROPERTY LINE	U.P.	UTILITY POLE
D.W.	DRYWELL	P.M.	PARKING METER	VCP	VITRIFIED CLAY PIPE
EE	ELECTRICAL EASEMENT	P.P.	POWER POLE	VG	VALLEY GUTTER
E.M.	ELECTRICAL METER	PUE	PUBLIC UTILITY EASEMENT	V _P	VOLUME PROVIDED
E.O.	ELECTRICAL OUTLET	R.D.	ROOF DRAIN	V _R	VOLUME REQUIRED
E.S.V.A.E.	EMERGENCY VEHICLE ACCESS EASEMENT	RIM	RIM ELEVATION	W.B.O.	WATER BLOW OFF
FF	FINISHED FLOOR	R/W	RIGHT-OF-WAY	WE	WATER EASEMENT
-G	FINISHED GROUND	S	SLOPE	W.F.	WATER FAUCET
-H	FIRE HYDRANT	SD	STORM DRAIN	WO	WALL OPENING
T/FT	FOOT PER FOOT	S.D.E.	STORM DRAIN EASEMENT	W.S.	WATER SERVICE
FL	FLOW LINE ELEVATION	SDMH	STORM DRAIN MANHOLE	WSE	WATER SURFACE ELEVATION
G	GUTTER ELEVATION	SE	SEWER EASEMENT	W&S.E.	WATER & SEWER EASEMENT
GB	GRADE BREAK				



Wood, Patel & Associates, In

602,335,8500

www.woodpatel.com



SRADING, DRAINAGE S SEWER PLAN DLER, ARIZONA NOTES PARK THE AT PRELIMINARY GRADII
WATER & SEWI

